

27 BONNETT DRIVE, RUN-O-WATERS, NSW LOT 24 DP 1053904 8 LOT RESIDENTIAL SUBDIVISION CIVIL ENGINEERING CONCEPT DESIGN

GOULBURN MULWAREE COUNCIL DEVELOPMENT CONSENT

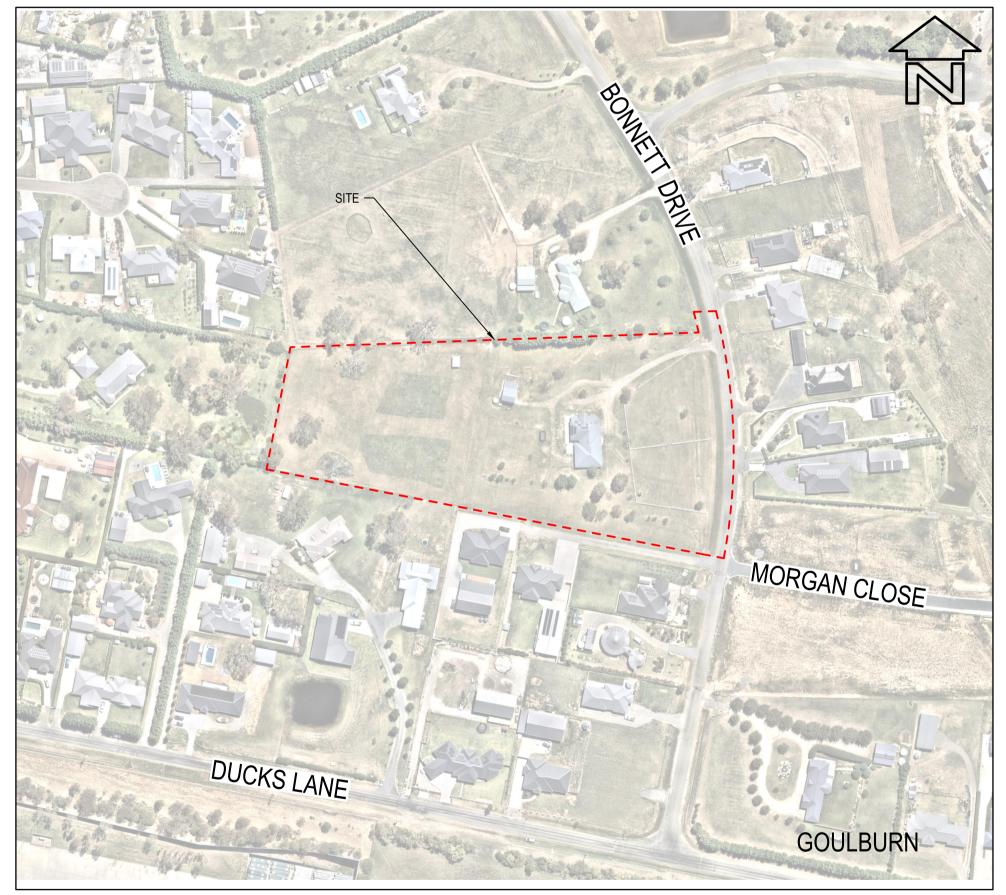

DRAWING SCHEDULE INDEX				
SHEET	TITLE	REVISION		
25022-GA-1000	COVER AND INDEX	0		
25022-GA-1005	GENERAL ARRANGEMENT PLAN	0		
25022-GA-1010	EXISTING AND SITE PREPARATION PLAN	0		
25022-GS-1100	SOIL AND WATER MANAGEMENT LAYOUT PLAN	0		
25022-GS-1101	SOIL AND WATER MANAGEMENT DETAILS	0		
25022-GV-1150	BULK EARTHWORKS PLAN	0		
25022-RD-1200	ROAD LAYOUT PLAN	0		
25022-RD-1230	ROAD 01 MC01 LONGITUDINAL AND TYPICAL SECTIONS	0		
25022-RD-1280	ROAD AND PAVEMENT TYPICAL DETAILS	0		
25022-SD-2000	DRAINAGE LAYOUT PLAN	0		
25022-SQ-2055	STORMWATER QUANTITY MODELLING PLAN	0		
25022-SQ-2056	STORMWATER QUALITY MODELLING PLAN 1 OF 2	0		
25022-SQ-2057	STORMWATER QUALITY MODELLING PLAN 2 OF 2	0		
25022-SE-3100	SEWER AND WATER NETWORK LAYOUT PLAN	0		

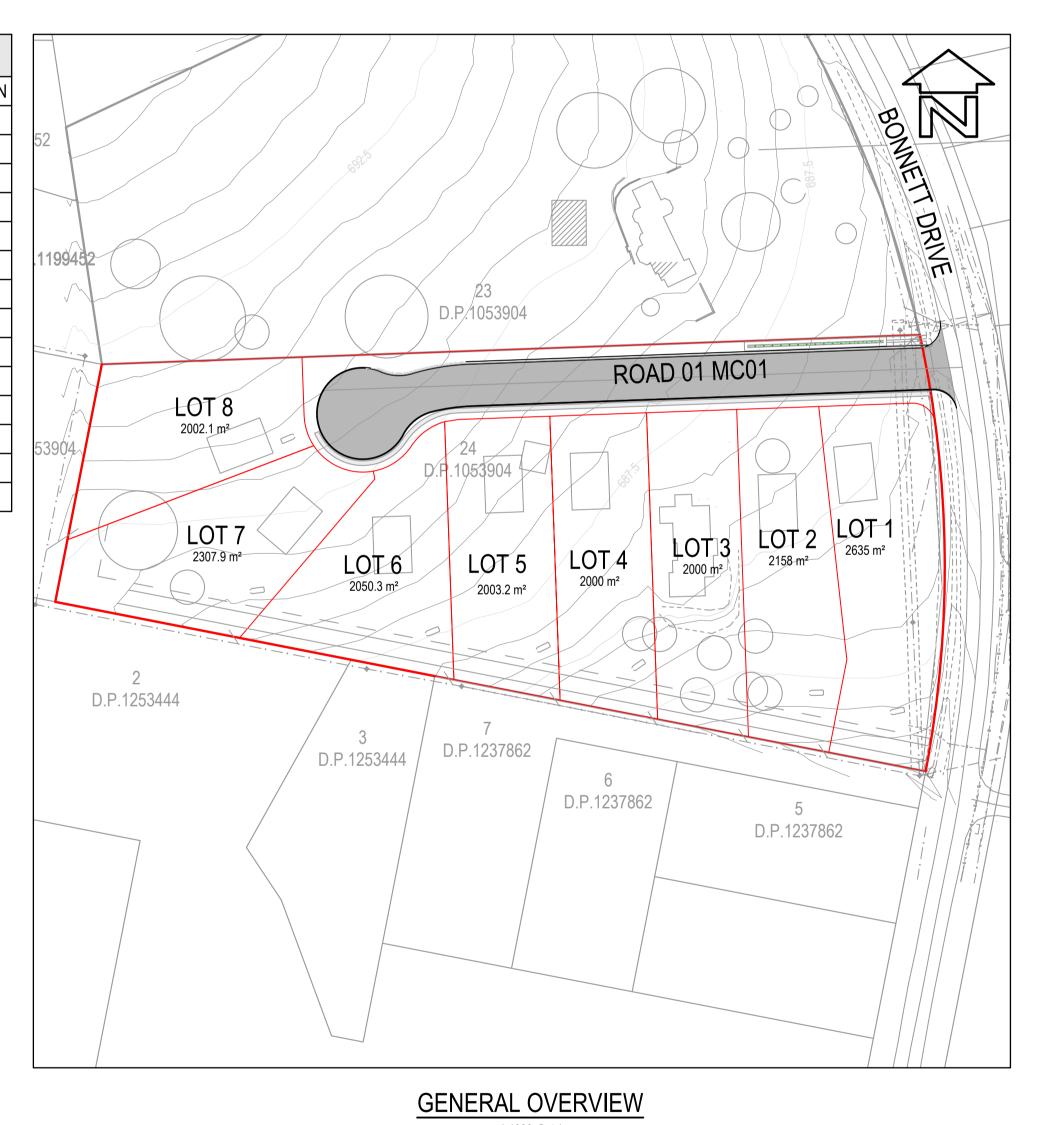

SITE LOCALITY PLAN

WARNING
BEWARE OF UNDERGROUND
SERVICES
THE LOCATION OF UNDERGROUND SERVICES ARE
APPROXIMATE ONLY AND THEIR EXACT POSITION
SHOULD BE PROVEN ON SITE. NO GUARANTEE IS
GIVEN THAT ALL EXISTING SERVICES ARE SHOWN.



DATE OF SURVEY: 28 MAR 2025

DATUM: MGA2020, AHD

SCALE: AS NOTED

SIZE: A1






SURVEY	LP	REV	DESCRIPTION	DATE
DESIGN	AD	0	SUBMISSION FOR DA APPROVAL	25 AUG 25
DRAWN	JN			
CHECKED	TP			
APPROVED	JW			

CIVPLAN PTY LIMITED ALL RIGHTS RESERVED. THIS DOCUMENT IS PRODUCED BY CIVPLAN PTY LTD SOLELY FOR THE BENEFIT OF AND USE BY THE CLIENT IN ACCORDANCE WITH THE TERMS OF THE RETAINER. CIVPLAN PTY LTD DOES NOT AND SHALL NOT ASSUME ANY RESPONSIBILITY OR LIABILITY WHATSOEVER TO ANY THIRD PARTY ARISING OUT OF ANY USE OF RELIANCE BY THIRD PARTY ON THE CONTENT OF THIS DOCUMENT.



OB NAME: 8 LOT RESIDENTIAL SUBDIVISION OCATION: 27 BONNETT DRIVE, RUN-O-WATERS, NSW LOT 24 DP 1053904	FOR CONCEPT APPROVAL NOT TO BE USED FOR CONSTRUCTION PURPOSES				
LGA: GOULBURN MULWAREE COUNCIL	RELEASE DATE: 25 AUGUST 2025				
CLIENT: KIMBLA PASTORAL COMPANY PTY LTD	JOB-DRAWING NUMBER	REV			
DESCRIPTION: CIVIL ENGINEERING CONCEPT DESIGN	25022-GA-1000				
DRAWING: COVER AND INDEX					

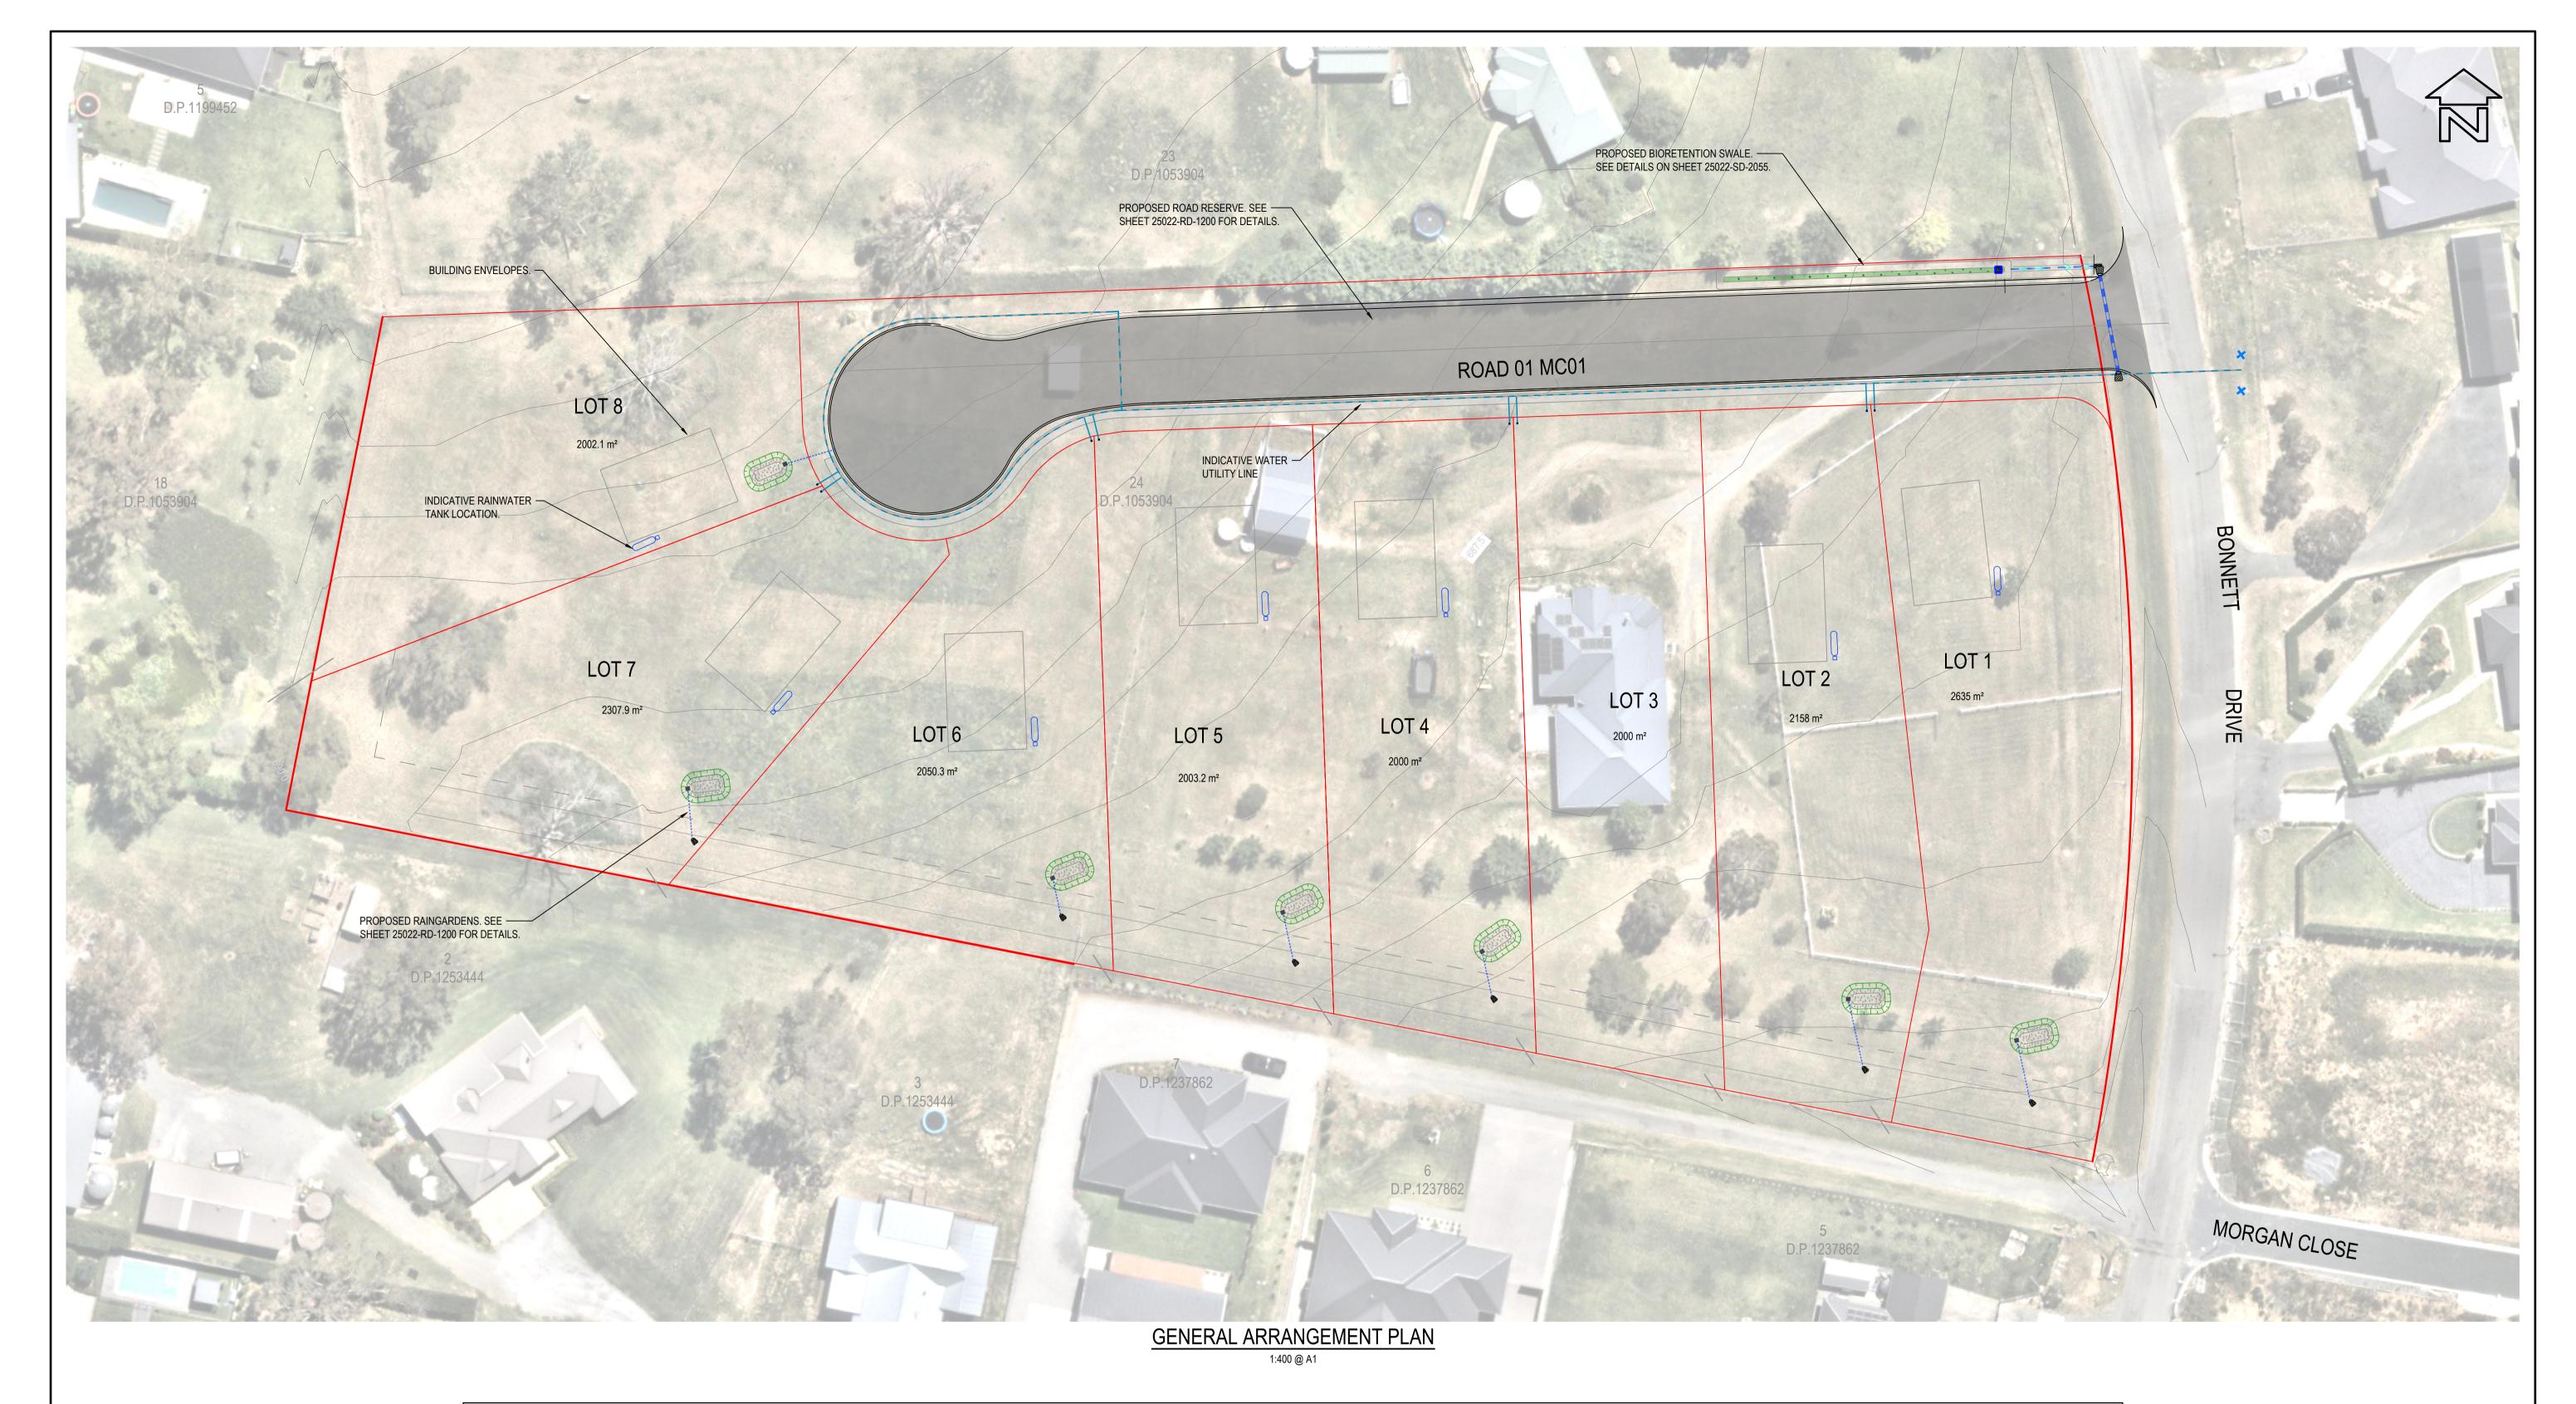

WARNING
BEWARE OF UNDERGROUND
SERVICES
THE LOCATION OF UNDERGROUND SERVICES ARE
APPROXIMATE ONLY AND THEIR EXACT POSITION
SHOULD BE PROVEN ON SITE. NO GUARANTEE IS
GIVEN THAT ALL EXISTING SERVICES ARE SHOWN.



GDA 2020

L
ſ

	SHEET LEGEND										
DESCRIPTION	DETAIL	DESCRIPTION	DETAIL	DESCRIPTION	DETAIL	DESCRIPTION	DETAIL	DESCRIPTION	DETAIL	DESCRIPTION	DETAIL
BARRIER KERB 'KG'	KG	KERB / PEDESTRIAN RAMP		SUB-SOIL AND FLUSH POINTS	_ss ss	STORMWATER LOCATION (EXISTING)	swsw	EXISTING WATER MAIN	W	EXISTING SEWER MAIN	s
ROLL KERB 'SA'	SA	NOMINAL CONTROL LINE		KERB ADAPTOR / OUTLET		SEWER LOCATION (EXISTING)	s	PROPOSED WATER MAIN	w	PROPOSED SEWER MAIN	s
EDGE RESTRAINT 'KS'	KS	ROAD PAVEMENT		LIMIT OF WORKS		WATER LOCATION (EXISTING)	W	PROPOSED HYDRANT	— 0 —	PROPOSED SEWER MANHOLE	s
KERB ONLY 'KO'	КО	PATH PAVING (CONCRETE)		PROPOSED LOT BOUNDARIES		TELSTRA LOCATION (EXISTING)	т	PROPOSED STOP VALVE	— × —	PROPOSED THRUST CONNECTOR	—] -
MOUNTABLE SF TYPE KERB 'SF'	SK	CONTOURS (MAJOR)	 25	TREE AND LANDSCAPING		FIBRE OPTICS LOCATION (EXISTING)		PROPOSED THRUST CONNECTOR	— —	PROPOSED SCOUR VALVE ASSEMBLY	_ 5 _
DISH DRAIN 'DD'	DD	CONTOURS (MINOR)		DRAINAGE PIT - 1.8m PIT WITH LINTEL		ELECTRICAL LOCATION (EXISTING)	— Е —	PROPOSED WATER SERVICE/METER		PROPOSED SEWER JUNCTION (I.O.)	s
VEHICULAR CROSSING		RETAINING WALL STRUCTURES		DRAINAGE PIT - 2.4m SAG WITH LINTEL		GAS LOCATION (EXISTING)	— - G — — G — —	PROPOSED THRUST BLOCK		PROPOSED THRUST BLOCK	

,	ı ا	l	15 1	20
	SCALE	:- 1:400		

SCALE: AS NOTED
SIZE: A1
DATE OF SURVEY: 28 MAR 2025
DATUM: MGA2020, AHD

SURVEY	LP	REV	DESCRIPTION	DATE
DESIGN	AD	0	SUBMISSION FOR DA APPROVAL	25 AUG 25
DRAWN	JN			
CHECKED	TP			
APPROVED	JW			

CIVPLAN PTY LIMITED ALL RIGHTS RESERVED.

THIS DOCUMENT IS PRODUCED BY CIVPLAN PTY LTD SOLELY FOR THE BENEFIT OF AND USE BY THE CLIENT IN ACCORDANCE WITH THE TERMS OF THE RETAINER. CIVPLAN PTY LTD DOES NOT AND SHALL NOT ASSUME ANY RESPONSIBILITY OR LIABILITY WHATSOEVER TO ANY THIRD PARTY ARISING OUT OF ANY USE OF RELIANCE BY THIRD PARTY ON THE CONTENT OF THIS DOCUMENT.


CIVPLAN
DEVELOPMENT & INFRASTRUCTURE CONSULTING
CIVPLAN PTY LTD ABN: 49 620 926 114 CIVPLAN CONSULTING PTY LTD ABN: 79 157 731 912
SOUTH COAST OFFICE: 390 PRINCES HIGHWAY, BOMADERRY NSW 2541
SYDNEY OFFICE: 152 SAILORS BAY ROAD, NORTHBRIDGE NSW 2063
T: 1800 318 052 E: info@civplan.com.au W: www.civplan.com.au

IOB NAME: 8 LOT RESIDENTIAL SUBDIVISION	FOR CONCEPT APPROVAL NOT TO BE USED FOR CONSTRUCTION PURPOSES			
LOCATION: 27 BONNETT DRIVE, RUN-O-WATERS, NSW LOT 24 DP 1053904				
LGA: GOULBURN MULWAREE COUNCIL	RELEASE DATE: 25 AUGUST 2025			
CLIENT: KIMBLA PASTORAL COMPANY PTY LTD	JOB-DRAWING NUMBER	REV		
DESCRIPTION: CIVIL ENGINEERING CONCEPT DESIGN	25022 CA 1005	0		
DRAWING: GENERAL ARRANGEMENT PLAN	25022-GA-1005	U		



WARNING
BEWARE OF UNDERGROUND
SERVICES
THE LOCATION OF UNDERGROUND SERVICES ARE
APPROXIMATE ONLY AND THEIR EXACT POSITION
SHOULD BE PROVEN ON SITE. NO GUARANTEE IS
GIVEN THAT ALL EXISTING SERVICES ARE SHOWN.



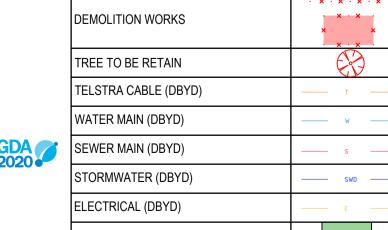

DETAIL DESCRIPTION TREES TO BE REMOVED · x · x · x · x · TREE PROTECTION

DEMOLITION AND SUBSEQUENT LAND REMEDIATION (IF REQUIRED) TO BE UNDERTAKEN IN ACCORDANCE WITH THE DA CONSENT, AUSTRALIAN STANDARDS, SAFEWORK NSW CODES OF PRACTICE AND EPA GUIDELINES

ALL CLEARING IS TO BE CONDUCTED AS APPROVED BY COUNCIL AND UNDER SUPERVISION OF AN ECOLOGIST IN ACCORDANCE WITH THE ECOLOGICAL MANAGEMENT PLAN (EMP).

ALL INTERNAL SERVICES TO BE ADJUSTED/ISOLATED AND RELEVANT INSPECTIONS COMPLETED PRIOR TO COMMENCEMENT OF DEMOLITION WORKS.

SCALE: AS NOTED
SIZE: A1
DATE OF SURVEY: 28 MAR 2025
DATUM: MGA2020, AHD


SURVEY	LP	REV	DESCRIPTION	DATE	
DESIGN	AD	0	SUBMISSION FOR DA APPROVAL	25 AUG 25	
DRAWN	JN				
CHECKED	TP				
APPROVED	JW				

CIVPLAN PTY LIMITED ALL RIGHTS RESERVED.

THIS DOCUMENT IS PRODUCED BY CIVPLAN PTY LTD SOLELY FOR THE BENEFIT OF AND USE BY THE CLIENT IN ACCORDANCE WITH THE TERMS OF THE RETAINER. CIVPLAN PTY LTD DOES NOT AND SHALL NOT ASSUME ANY RESPONSIBILITY OR LIABILITY WHATSOEVER TO ANY THIRD PARTY ARISING OUT OF ANY USE OF RELIANCE BY THIRD PARTY ON THE CONTENT OF THIS DOCUMENT.

CIVPLAN
DEVELOPMENT & INFRASTRUCTURE CONSULTING
LAN PTY LTD ABN: 49 620 926 114 CIVPLAN CONSULTING PTY LTD ABN: 79 157
SOUTH COAST OFFICE: 390 PRINCES HIGHWAY, BOMADERRY NSW 2541
SYDNEY OFFICE: 152 SAILORS BAY ROAD, NORTHBRIDGE NSW 2063
T: 1800 318 052 E: info@civplan.com.au W: www.civplan.com.au

JOB NAME: 8 LOT RESIDENTIAL SUBDIVISION LOCATION: 27 BONNETT DRIVE, RUN-O-WATERS, NSW LOT 24 DP 1053904	FOR CONCEPT APPROVAL NOT TO BE USED FOR CONSTRUCTION PURPOSES			
LGA: GOULBURN MULWAREE COUNCIL	RELEASE DATE: 25 AUGUST 2025			
CLIENT: KIMBLA PASTORAL COMPANY PTY LTD	JOB-DRAWING NUMBER	REV		
DESCRIPTION: CIVIL ENGINEERING CONCEPT DESIGN	25022 CA 4040			
DRAWING: EXISTING AND SITE PREPERATION PLAN	25022-GA-1010	U		

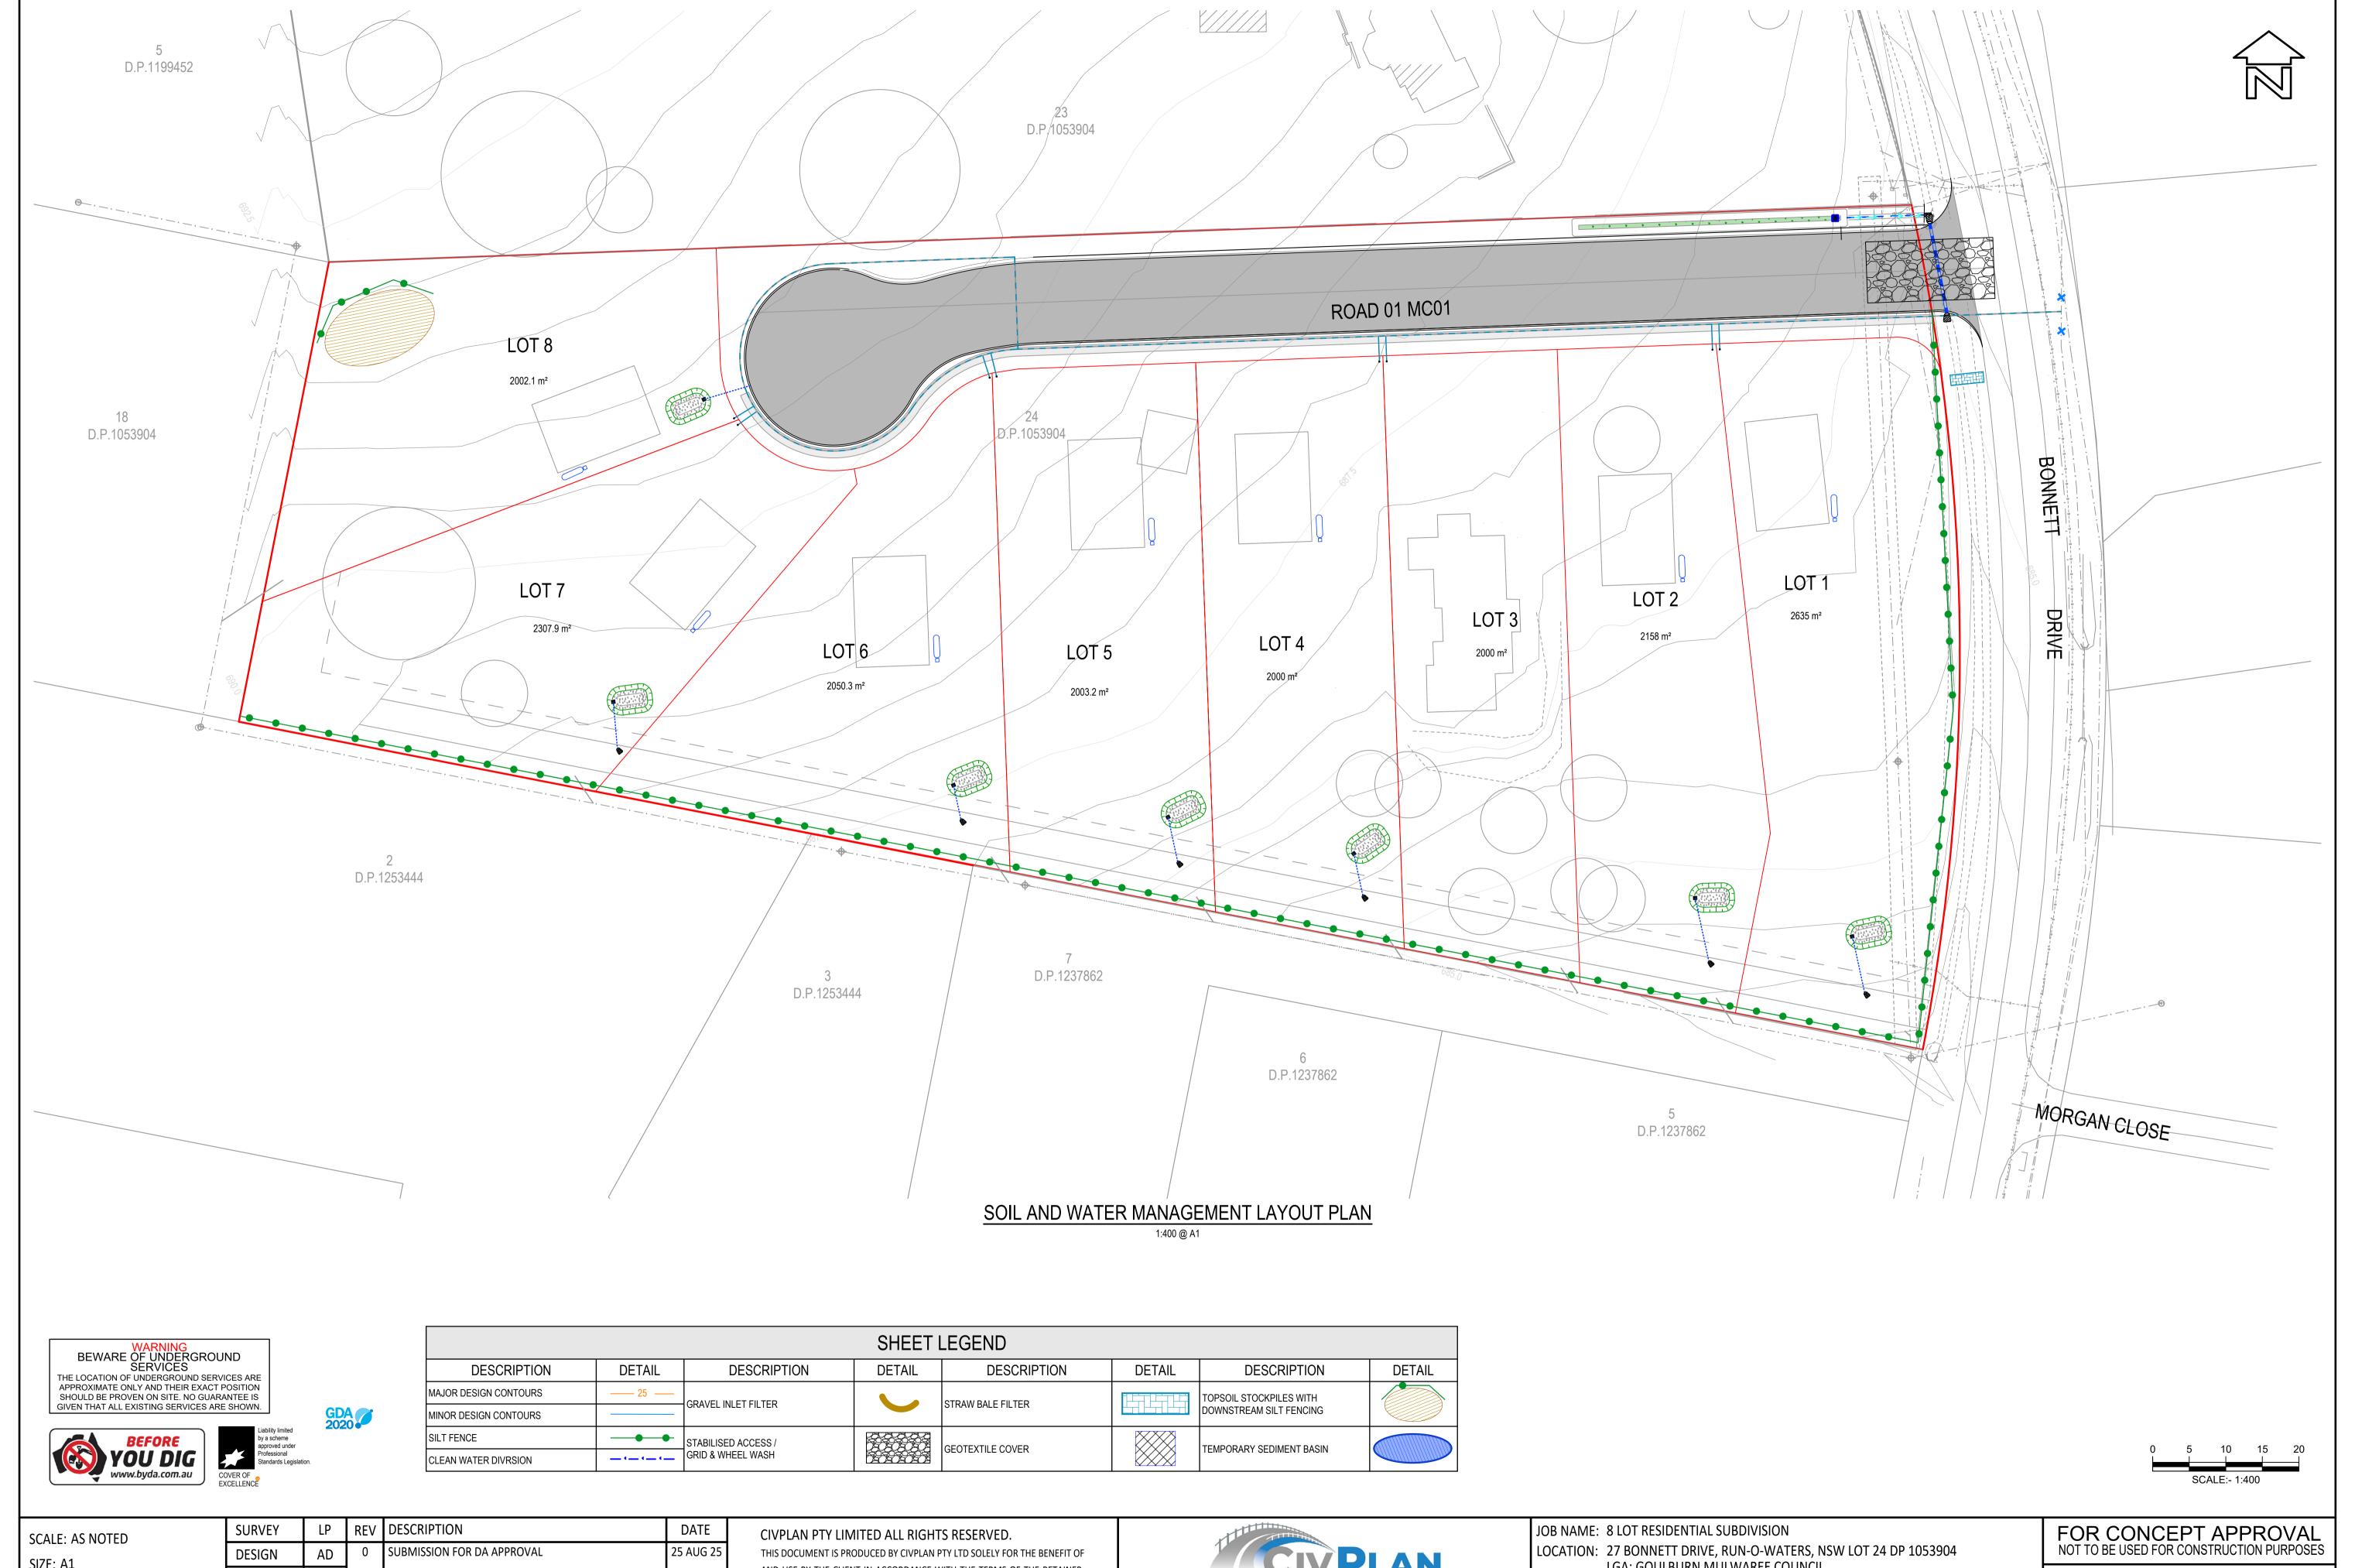

SCALE: AS NOTED

SIZE: A1

DATE OF SURVEY: 28 MAR 2025

DATUM: MGA2020, AHD

SURVEY LP REV DESCRIPTION DATE

DESIGN AD 0 SUBMISSION FOR DA APPROVAL 25 AUG 25

DRAWN JN


CHECKED TP

APPROVED JW

THIS DOCUMENT IS PRODUCED BY CIVPLAN PTY LTD SOLELY FOR THE BENEFIT OF AND USE BY THE CLIENT IN ACCORDANCE WITH THE TERMS OF THE RETAINER. CIVPLAN PTY LTD DOES NOT AND SHALL NOT ASSUME ANY RESPONSIBILITY OR LIABILITY WHATSOEVER TO ANY THIRD PARTY ARISING OUT OF ANY USE OF RELIANCE BY THIRD PARTY ON THE CONTENT OF THIS DOCUMENT.

CIVPLAN
DEVELOPMENT & INFRASTRUCTURE CONSULTING
CIVPLAN PTY LTD ABN: 49 620 926 114 CIVPLAN CONSULTING PTY LTD ABN: 79 157 731 912
SOUTH COAST OFFICE: 390 PRINCES HIGHWAY, BOMADERRY NSW 2541
SYDNEY OFFICE: 152 SAILORS BAY ROAD, NORTHBRIDGE NSW 2063
T: 1800 318 052 E: info@civplan.com.au W: www.civplan.com.au


JOB NAME: 8 LOT RESIDENTIAL SUBDIVISION LOCATION: 27 BONNETT DRIVE, RUN-O-WATERS, NSW LOT 24 DP 1053904	FOR CONCEPT APPROVAL NOT TO BE USED FOR CONSTRUCTION PURPOSES		
LGA: GOULBURN MULWAREE COUNCIL	RELEASE DATE: 25 AUGUST 2025		
CLIENT: KIMBLA PASTORAL COMPANY PTY LTD	JOB-DRAWING NUMBER	REV	
DESCRIPTION: CIVIL ENGINEERING CONCEPT DESIGN	25022 00 4400		
DRAWING: SOIL AND WATER MANAGEMENT LAYOUT PLAN	25022-GS-1100	U	

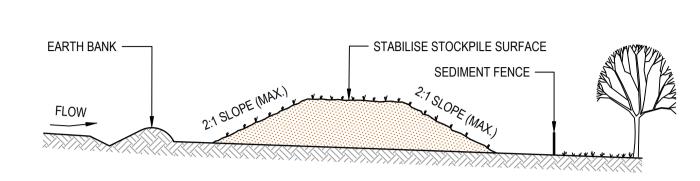

CONSTRUCTION NOTES

- 1. PLACE STOCKPILES MORE THAN 2m (PREFERABLY 5m) FROM EXISTING VEGETATION, CONCENTRATED WATER FLOW, ROADS AND HAZARD AREAS.
- 2. CONSTRUCT ON THE CONTOUR AS LOW, FLAT, ELONGATED MOUNDS.
- 3. WHERE THERE IS SUFFICIENT AREA, TOPSOIL STOCKPILES SHALL BE LESS THAN 2m IN HEIGHT.
- 4. WHERE THEY ARE TO BE IN PLACE FOR MORE THAN 10 DAYS, STABILISE FOLLOWING THE APPROVED ESCP OR SWMP TO REDUCE THE C-FACTOR TO LESS THAN 0.10.
- 5. CONSTRUCT EARTH BANKS (STANDARD DRAWING 5-5) ON THE UPSLOPE SIDE TO DIVERT WATER AROUND STOCKPILES AND SEDIMENT FENCES (STANDARD DRAWING 6-8) 1 TO 2m DOWNSLOPE.


STOCKPILES (SD 4-1)

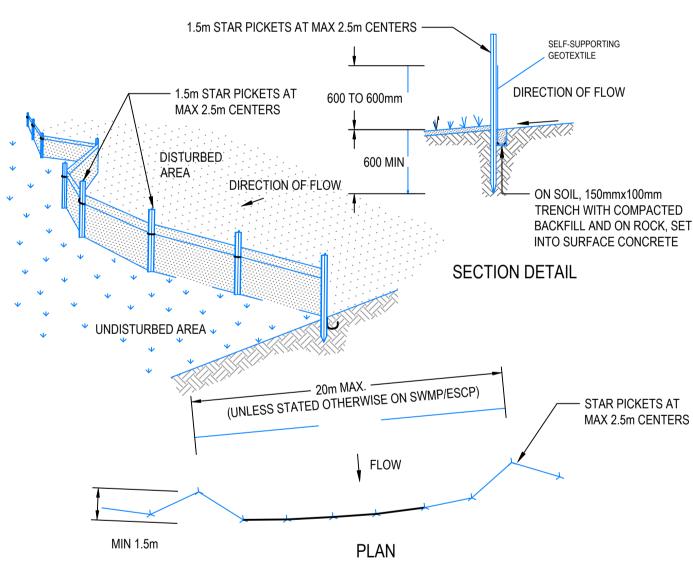

CONSTRUCTION NOTES

- 1. CONSTRUCT SEDIMENT FENCES AS CLOSE AS POSSIBLE TO BEING PARALLEL TO THE CONTOURS OF THE SITE, BUT WITH SMALL RETURNS AS SHOWN IN THE DRAWING TO LIMIT THE CATCHMENT AREA OF ANY ONE SECTION. THE CATCHMENT AREA SHOULD BE SMALL ENOUGH TO LIMIT WATER FLOW IF CONCENTRATED AT ONE POINT TO 50 LITRES PER SECOND IN THE DESIGN STORM EVENT, USUALLY THE 10-YEAR EVENT.
- 2. CUT A 150mm DEEP TRENCH ALONG THE UPSLOPE LINE OF THE FENCE FOR THE BOTTOM OF THE FABRIC TO BE ENTRENCHED.
- DRIVE 1.5 METRE LONG STAR PICKETS INTO GROUND AT 2.5 METRE INTERVALS (MAX) AT THE DOWNSLOPE EDGE
 OF THE TRENCH. ENSURE ANY STAR PICKETS ARE FITTED WITH SAFETY CAPS.
- 4. FIX SELF-SUPPORTING GEOTEXTILE TO THE UPSLOPE SIDE OF THE POSTS ENSURING IT GOES TO THE BASE OF THE TRENCH. FIX THE GEOTEXTILE WITH WIRE TIES OR AS RECOMMENDED BY THE MANUFACTURER. ONLY USE GEOTEXTILE SPECIFICALLY PRODUCED FOR SEDIMENT FENCING. THE USE OF SHADE CLOTH FOR THIS PURPOSE IS NOT SATISFACTORY.
- 5. JOIN SECTIONS OF FABRIC AT A SUPPORT POST WITH A 150mm OVERLAP.
- 6. BACKFILL THE TRENCH OVER THE BASE OF THE FABRIC AND COMPACT IT THOROUGHLY OVER THE GEOTEXTILE.


SEDIMENT FENCE (SD 6-8)

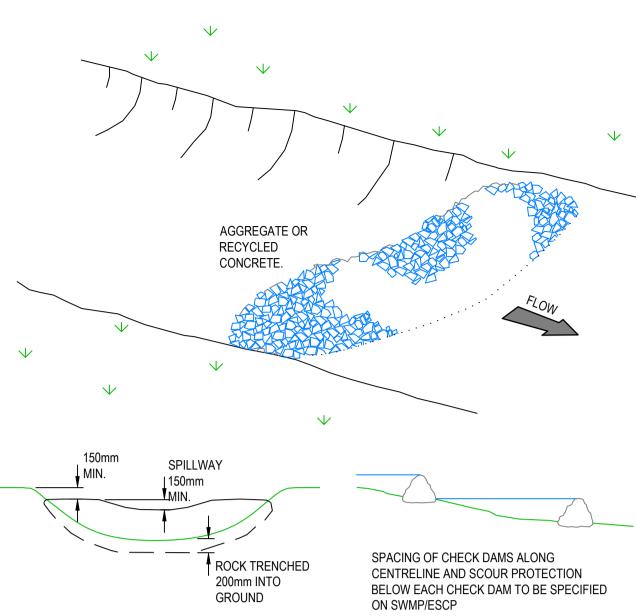

CONSTRUCTION NOTES

- CHECK DAMS CAN BE BUILT WITH VARIOUS MATERIALS, INCLUDING ROCKS, LOGS, SANDBAGS AND STRAW BALES.
 THE MAINTENANCE PROGRAM SHOULD ENSURE THEIR INTEGRITY IS RETAINED, ESPECIALLY WHERE CONSTRUCTED
 WITH STRAW BALES. IN THE CASE OF BALES, THIS MIGHT REQUIRE THEIR REPLACEMENT EACH TWO TO FOUR
 MONTHS.
- 2. TRENCH THE CHECK DAM 200mm INTO THE GROUND ACROSS ITS WHOLE WIDTH. WHERE ROCK IS USED, FILL THE TRENCHES TO AT LEAST 100mm ABOVE THE GROUND SURFACE TO REDUCE THE RISK OF UNDERCUTTING.
- 3. NORMALLY, THEIR MAXIMUM HEIGHT SHOULD NOT EXCEED 600mm ABOVE THE GULLY FLOOR. THE CENTRE SHOULD ACT AS A SPILLWAY, BEING AT LEAST 150mm LOWER THAN THE OUTER EDGES.
- 4. SPACE THE DAMS SO THE TOE OF THE UPSTREAM DAM IS LEVEL WITH THE SPILLWAY OF THE NEXT DOWNSTREAM

ROCK CHECK DAM (SD 5-4)

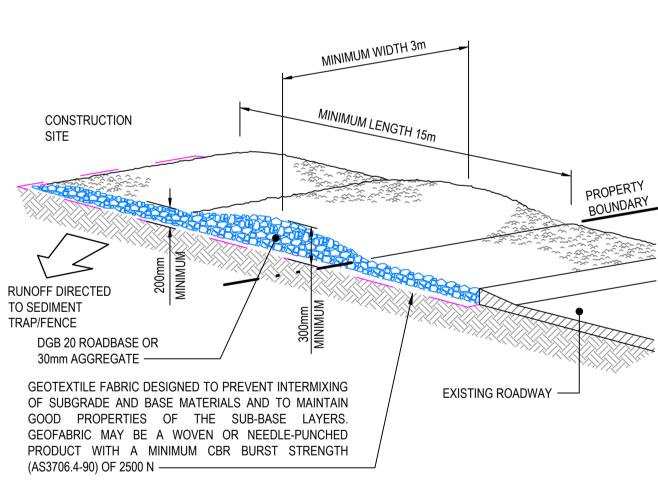

ALTERNATIVE OPTION - VIBRATING ACCESS GRID

PENDING PREFERANCE OF THE NOMINATED MANAGING CONTRACTOR A VIBRATING ACCESS GRID CAN ALSO BE UTLISED DURING CONSTRUCTION. FOR FURTHER DETAILS PLEASE REFER TO THE CATCHMENTS AND CREEKS STANDARD "CONSTRUCTION EXITS - VIBRATION GRIDS - SEDIMENT CONTROL TECHNIQUE - VERSION 2 - APRIL 2010".


CONSTRUCTION NOTES

DATE

25 AUG 25

- 1. STRIP THE TOPSOIL, LEVEL THE SITE AND COMPACT THE SUBGRADE.
- 2. COVER THE AREA WITH NEEDLE-PUNCHED GEOTEXTILE.
- CONSTRUCT A 200mm THICK PAD OVER THE GEOTEXTILE USING ROAD BASE OR 30mm AGGREGATE.
 ENSURE THE STRUCTURE IS AT LEAST 15 METRES LONG OR TO BUILDING ALIGNMENT AND AT LEAST 3 METRES WIDE.
- 5. WHERE A SEDIMENT FENCE JOINS ONTO THE STABILISED ACCESS, CONSTRUCT A HUMP IN THE STABILISED ACCESS
 - TO DIVERT WATER TO THE SEDIMENT FENCE.

STABILISED SITE ACCESS (SD 6-14)

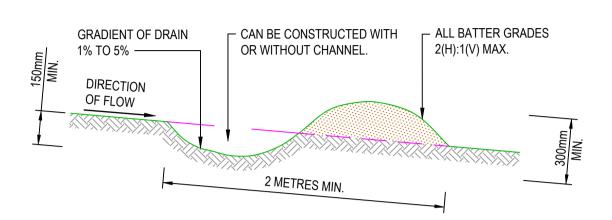


CONSTRUCTION NOTES

- 1. BUILD WITH GRADIENTS BETWEEN 1 AND 5 PERCENT.
- 2. AVOID REMOVING TREES AND SHRUBS IF POSSIBLE WORK AROUND THEM.
- 3. ENSURE THE STRUCTURES ARE FREE OF PROJECTIONS OR OTHER IRREGULARITIES THAT COULD IMPEDE WATER FLOW.
- 4. BUILD THE DRAINS WITH CIRCULAR, PARABOLIC OR TRAPEZOIDAL CROSS SECTIONS, NOT V SHAPED.
- 5. ENSURE THE BANKS ARE PROPERLY COMPACTED TO PREVENT FAILURE.
- 6. COMPLETE PERMANENT OR TEMPORARY STABILISATION WITHIN 10 DAYS OF CONSTRUCTION.

NOTE: ONLY TO BE USED AS TEMPORARY BANK WHERE MAXIMUM UPSLOPE LENGTH IS 80 METRES.

EARTH BANK - LOW FLOW (SD 5-5)

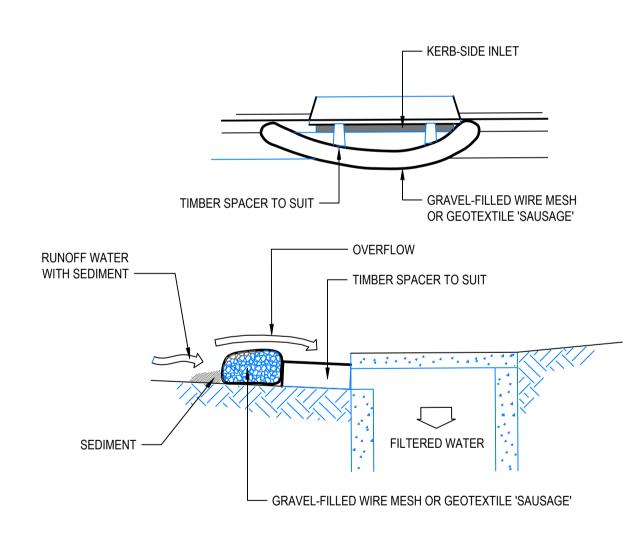


NOTE: THIS PRACTICE ONLY TO BE USED WHERE SPECIFIED IN APPROVED SWMP/ESCP

CONSTRUCTION NOTES

- 1. INSTALL FILTERS TO KERB INLETS ONLY AT SAG POINTS.
- 2. FABRICATE A SLEEVE MADE FROM GEOTEXTILE OR WIRE MESH LONGER THAN THE LENGTH OF THE INLET PIT AND FILL IT WITH 25mm TO 50mm GRAVEL.
- 3. FORM AN ELLIPTICAL CROSS-SECTION ABOUT 150mm HIGH x 400mm WIDE.
- 4. PLACE THE FILTER AT THE OPENING LEAVING AT LEAST A 100mm SPACE BETWEEN IT AND THE KERB INLET. MAINTAIN THE OPENING WITH SPACER BLOCKS.
- 5. FORM A SEAL WITH THE KERB TO PREVENT SEDIMENT BYPASSING THE FILTER.
- 6. SANDBAGS FILLED WITH GRAVEL CAN SUBSTITUTE FOR THE MESH OR GEOTEXTILE PROVIDING THEY ARE PLACED SO THAT THEY FIRMLY ABUT EACH OTHER AND SEDIMENT-LADEN WATERS CANNOT PASS BETWEEN.

MESH AND GRAVEL INLET FILTER (SD 6-11)

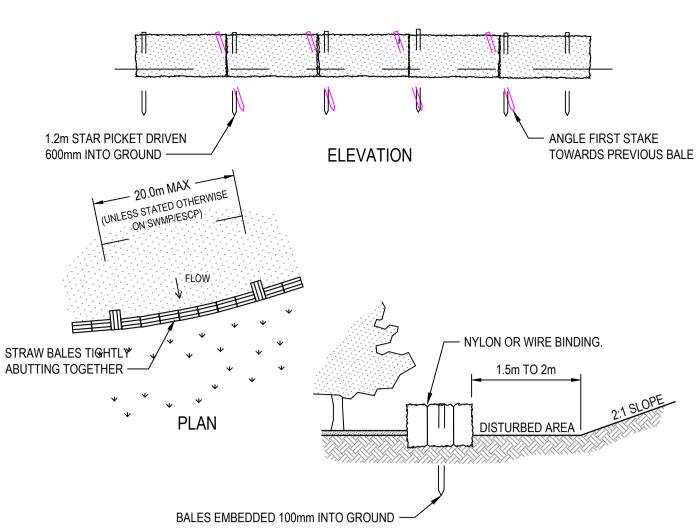


CONSTRUCTION NOTES

- 1. CONSTRUCT THE STRAW BALE FILTER AS CLOSE AS POSSIBLE TO BEING PARALLEL TO THE CONTOURS OF THE
- 2. PLACE BALES LENGTHWISE IN A ROW WITH ENDS TIGHTLY ABUTTING. USE STRAW TO FILL ANY GAPS BETWEEN
- BALES. STRAWS ARE TO BE PLACED PARALLEL TO GROUND.

 3. ENSURE THAT THE MAXIMUM HEIGHT OF THE FILTER IS ONE BALE.
- 4. EMBED EACH BALE IN THE GROUND 75mm TO 100mm AND ANCHOR WITH TWO 1.2 METRE STAR PICKETS OR STAKES. ANGLE THE FIRST STAR PICKET OR STAKE IN EACH BALE TOWARDS THE PREVIOUSLY LAID BALE. DRIVE THEM 600mm INTO THE GROUND AND, IF POSSIBLE, FLUSH WITH THE TOP OF THE BALES. WHERE STAR PICKETS ARE USED AND THEY PROTRUDE ABOVE THE BALES, ENSURE THEY ARE FITTED WITH SAFETY CAPS.
- 5. WHERE A STRAW BALE FILTER IS CONSTRUCTED DOWNSLOPE FROM A DISTURBED BATTER, ENSURE THE BALES ARE PLACED 1 TO 2 METRES DOWNSLOPE FROM THE TOE.
- 6. ESTABLISH A MAINTENANCE PROGRAM THAT ENSURES THE INTEGRITY OF THE BALES IS RETAINED THEY COULD REQUIRE REPLACEMENT EACH TWO TO FOUR MONTHS.

STRAW BALE FILTER (SD 6-7)

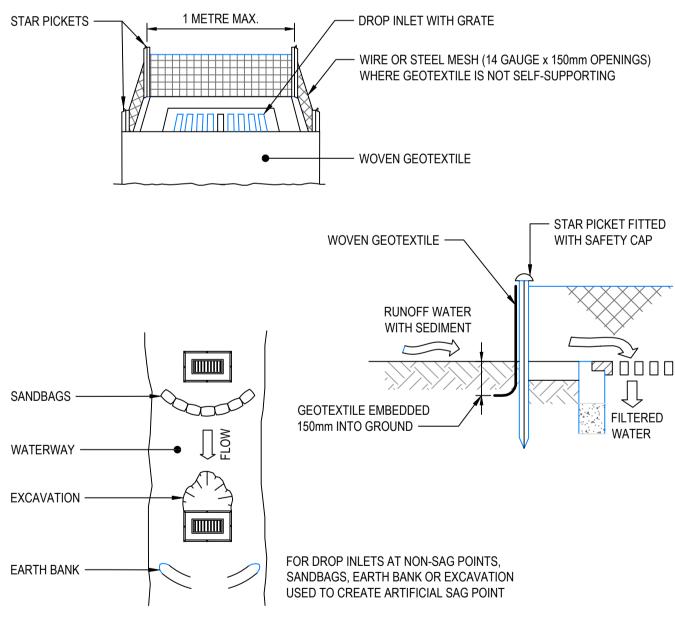

CONSTRUCTION NOTES

- FABRICATE A SEDIMENT BARRIER MADE FROM GEOTEXTILE OR STRAW BALES.
- 2. FOLLOW STANDARD DRAWING 6-7 AND STANDARD DRAWING 6-8 FOR INSTALLATION PROCEDURES FOR THE STRAW BALES OR GEOFABRIC. REDUCE THE PICKET SPACING TO 1 METRE CENTRES.
- 3. IN WATERWAYS, ARTIFICIAL SAG POINTS CAN BE CREATED WITH SANDBAGS OR EARTH BANKS AS SHOWN IN THE DRAWING
- 4. DO NOT COVER THE INLET WITH GEOTEXTILE UNLESS THE DESIGN IS ADEQUATE TO ALLOW FOR ALL WATERS TO BYPASS IT.

GEOTEXTILE INLET FILTER (SD 6-12)

SCALE: AS NOTED SIZE: A1 DATE OF SURVEY: 28 MAR 2025 DATUM: MGA2020, AHD SURVEY LP REV DESCRIPTION O SUBMISSION FOR DA APPROVAL TP


APPROVED


CIVPLAN PTY LIMITED ALL RIGHTS RESERVED.


THIS DOCUMENT IS PRODUCED BY CIVPLAN PTY LTD SOLELY FOR THE BENEFIT OF AND USE BY THE CLIENT IN ACCORDANCE WITH THE TERMS OF THE RETAINER. CIVPLAN PTY LTD DOES NOT AND SHALL NOT ASSUME ANY RESPONSIBILITY OR LIABILITY WHATSOEVER TO ANY THIRD PARTY ARISING OUT OF ANY USE OF RELIANCE BY THIRD PARTY ON THE CONTENT OF THIS DOCUMENT.




OB NAME: 8 LOT RESIDENTIAL SUBDIVISION	FOR CONCEPT APPROVAL		
OCATION: 27 BONNETT DRIVE, RUN-O-WATERS, NSW LOT 24 DP 1053904	NOT TO BE USED FOR CONSTRUCTION PURPOSES		
LGA: GOULBURN MULWAREE COUNCIL	RELEASE DATE: 25 AUGUST 2025		
CLIENT: KIMBLA PASTORAL COMPANY PTY LTD	JOB-DRAWING NUMBER	REV	
DESCRIPTION: CIVIL ENGINEERING CONCEPT DESIGN	25022-GS-1101	_	
DRAWING: SOIL AND WATER MANAGEMENT DETAILS	23022-G3-1101	U	

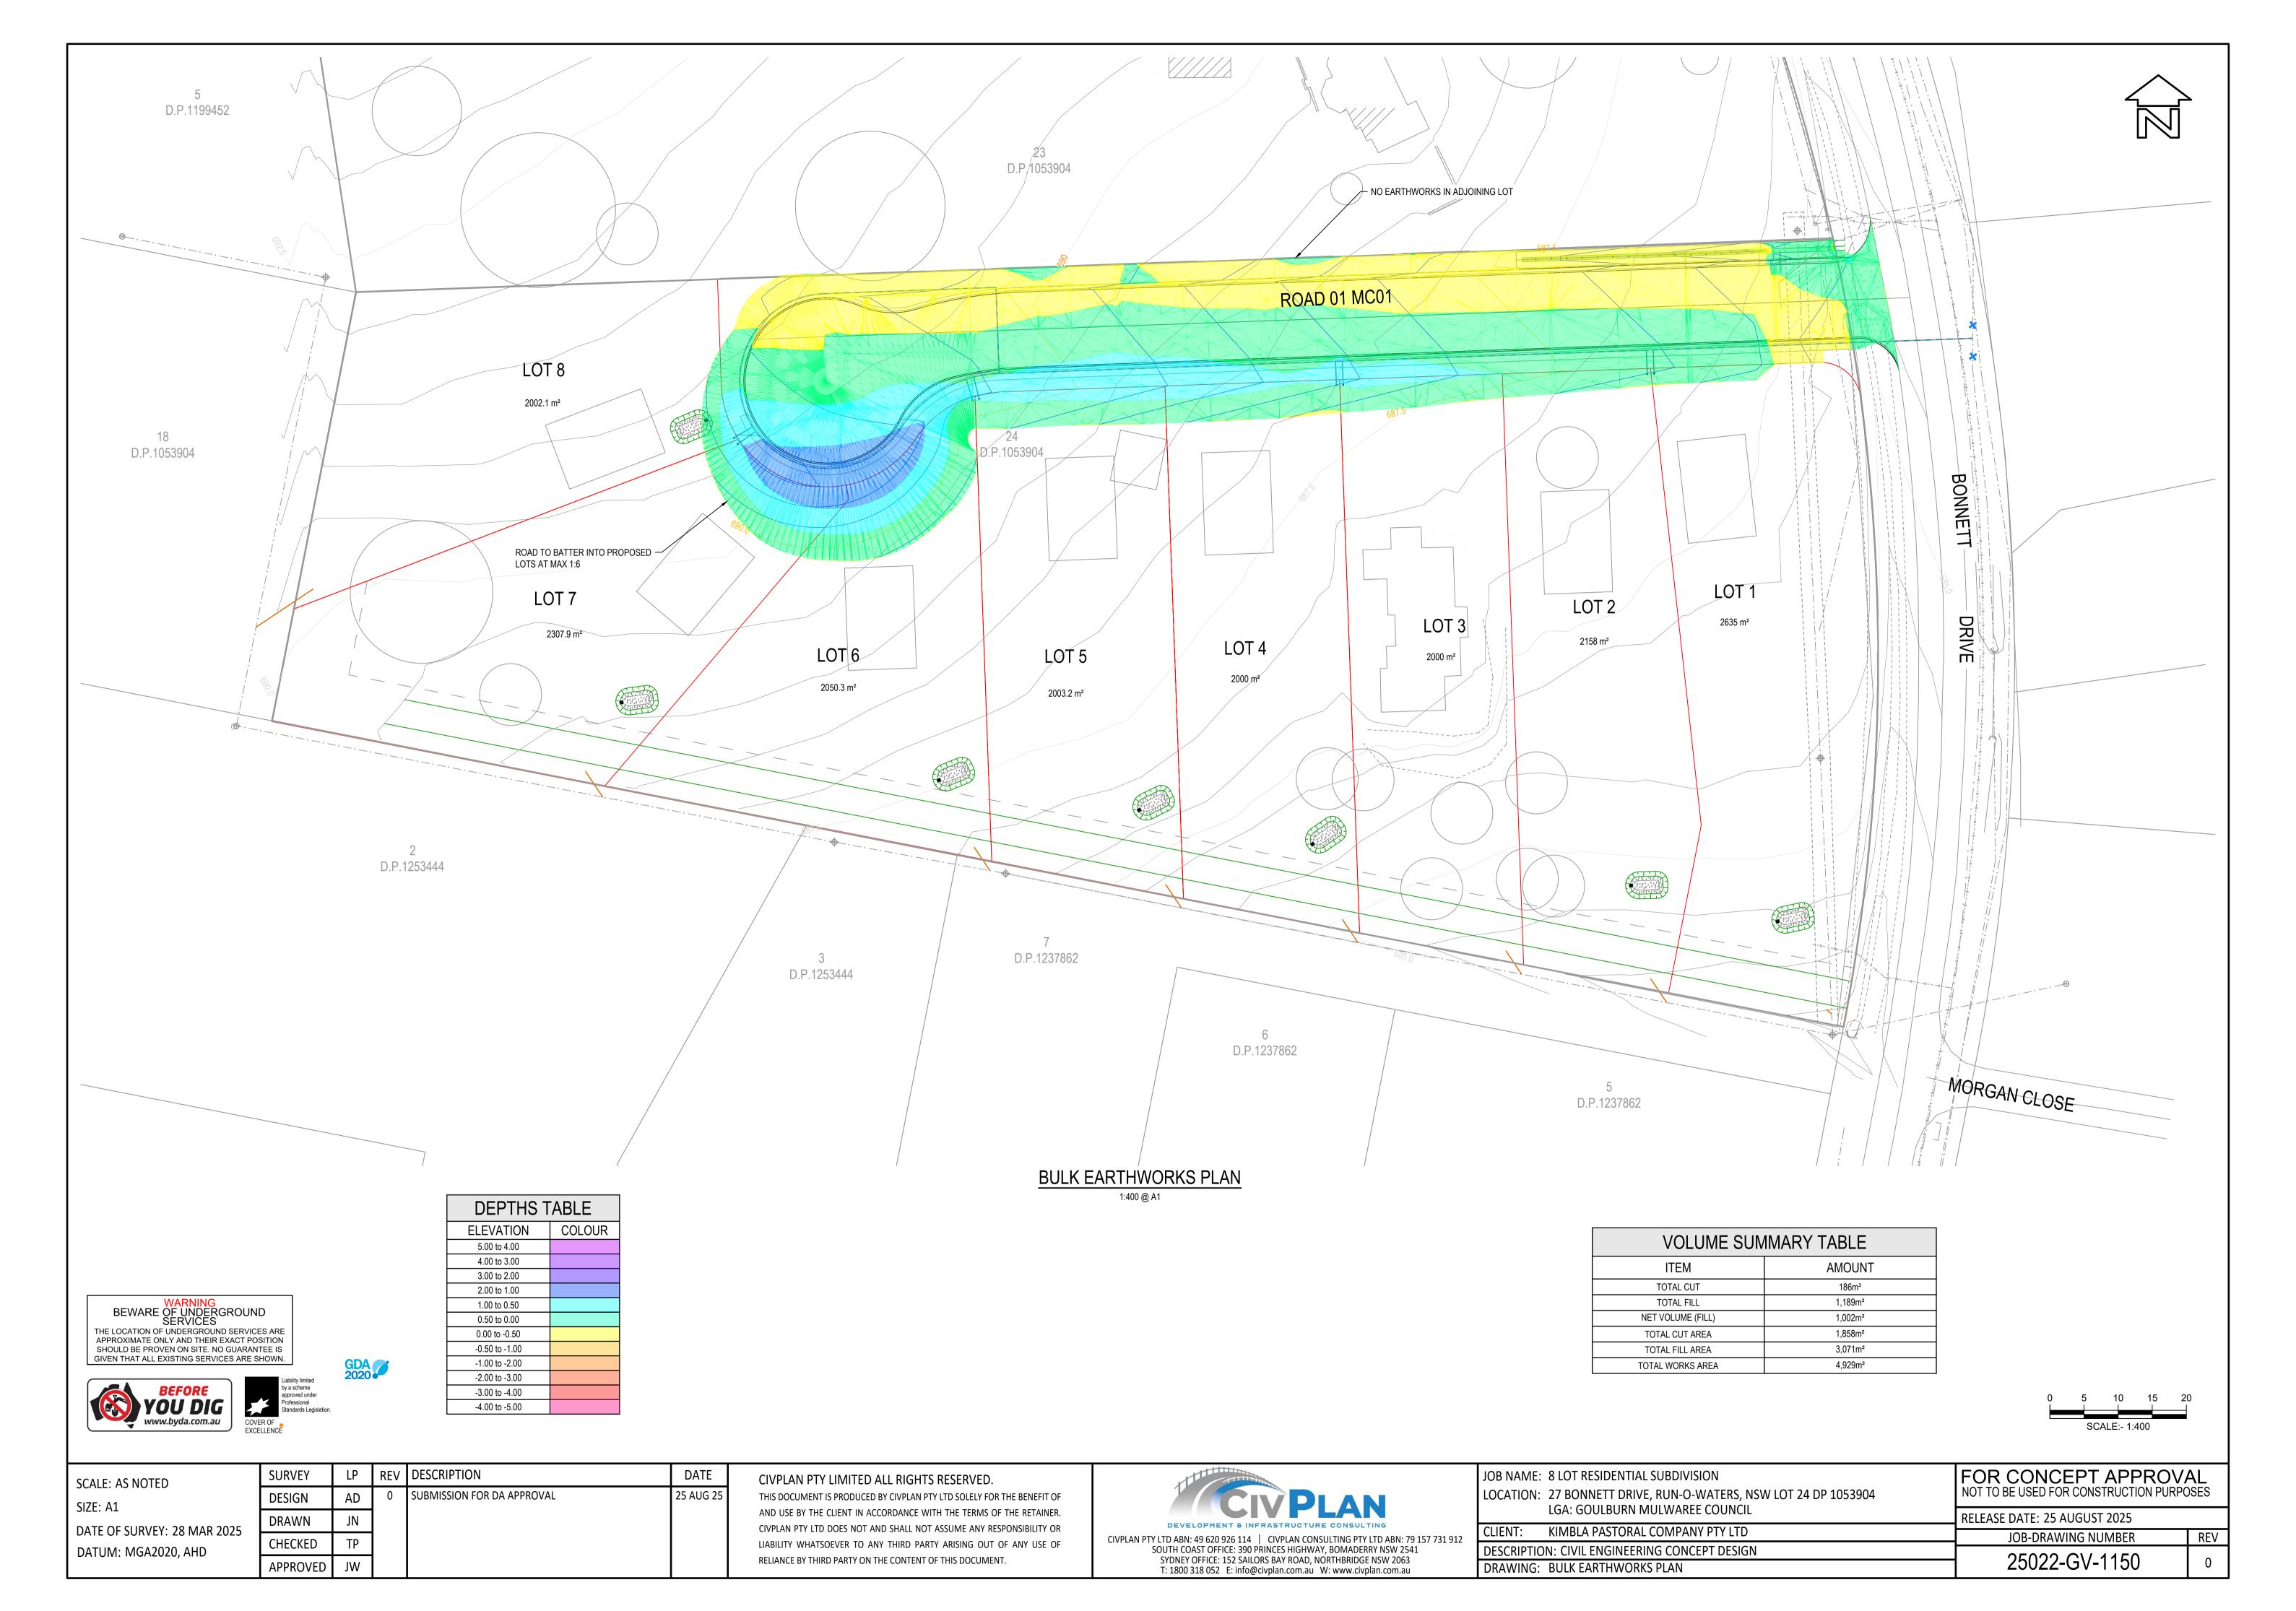

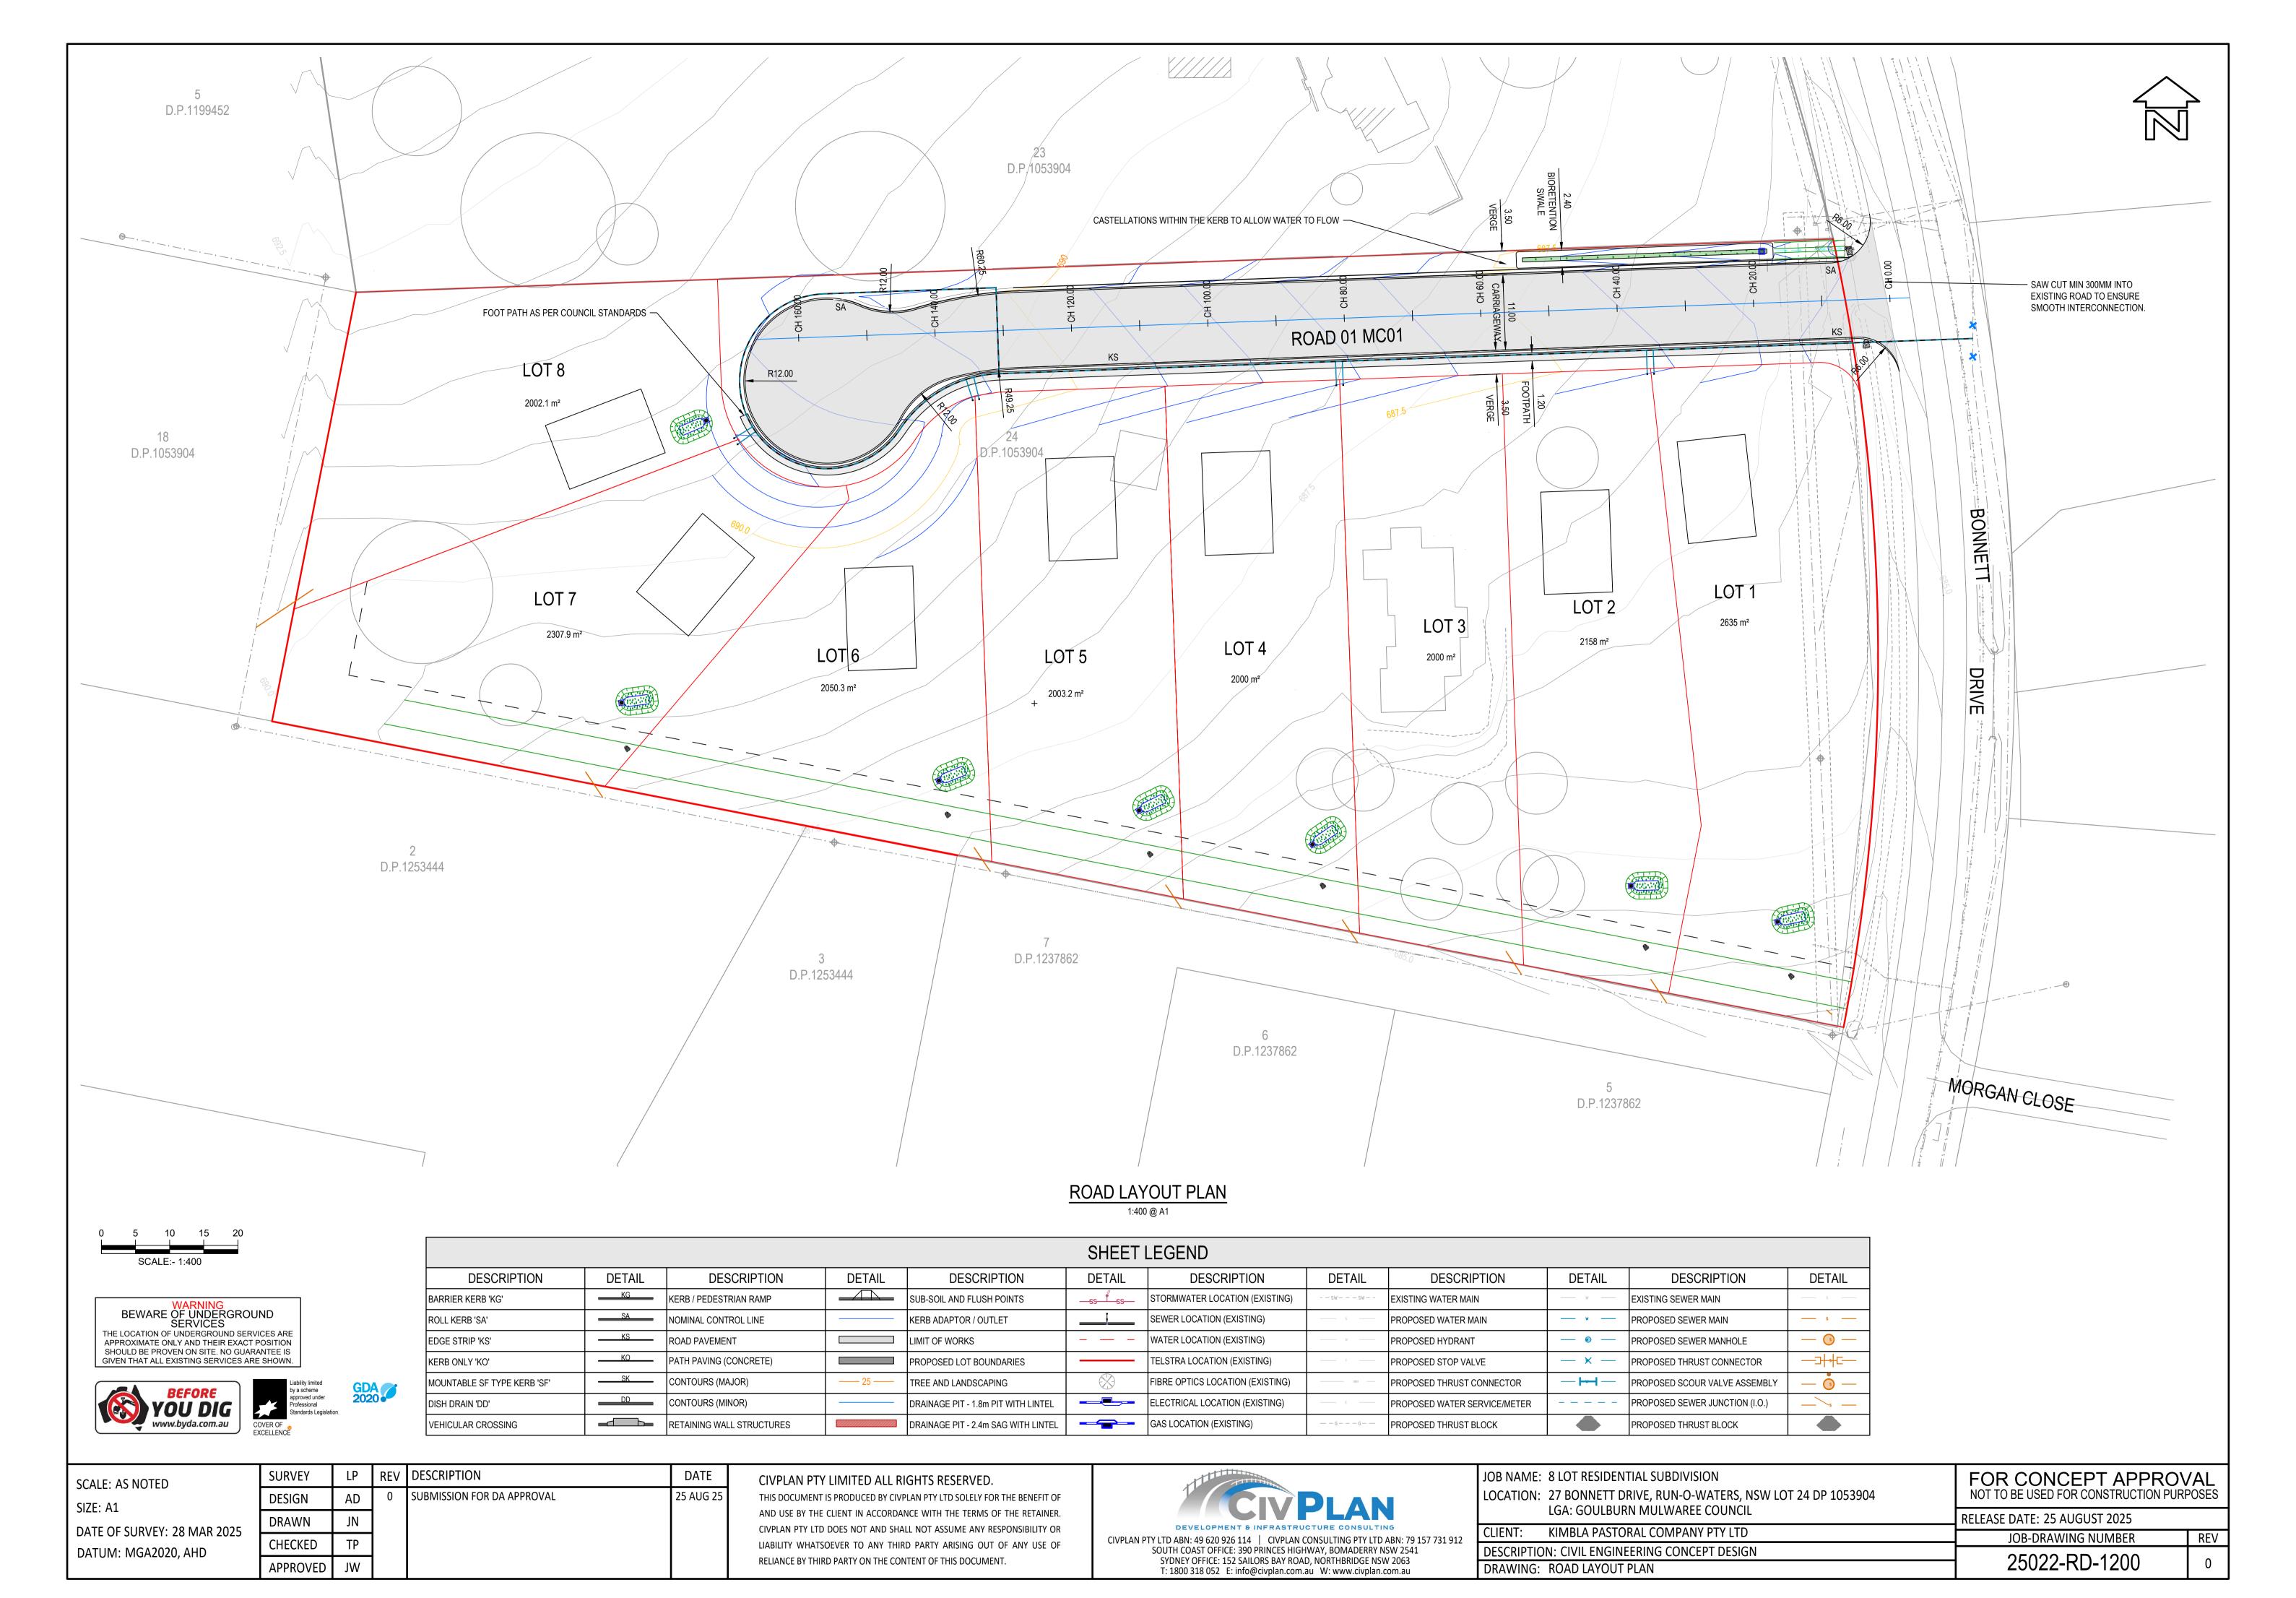

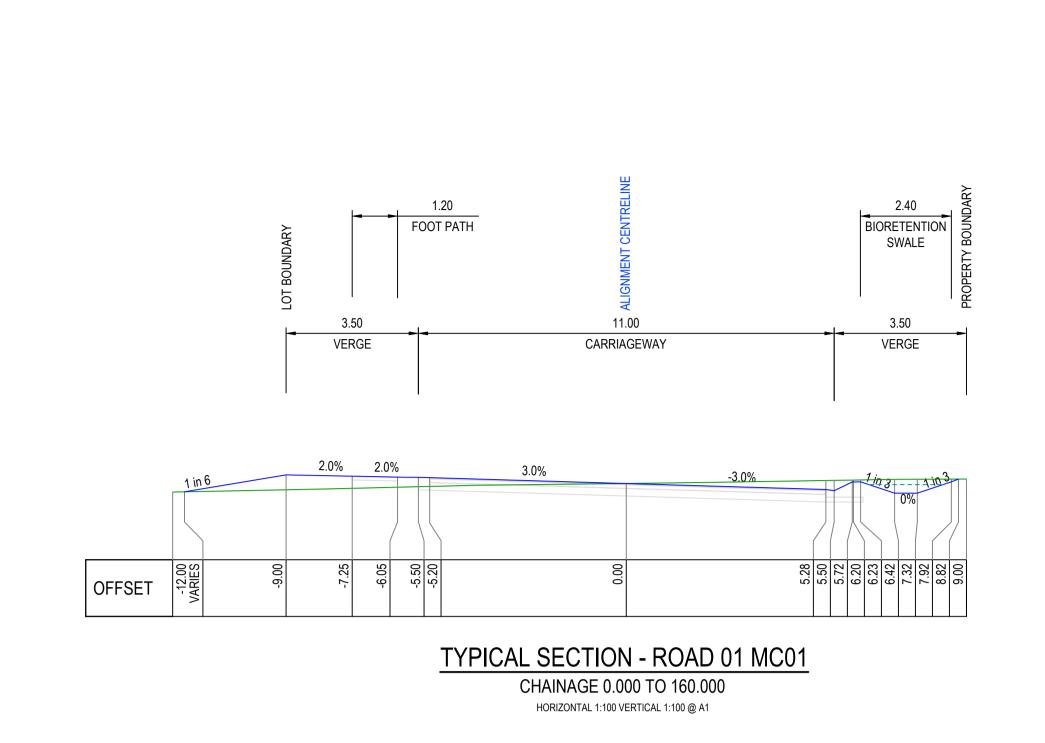

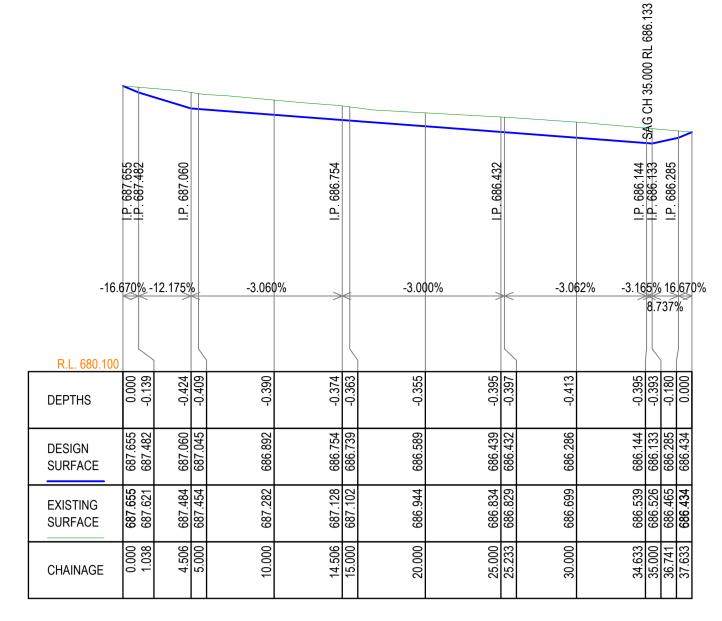

LONGITUDINAL SECTION - BIORETENTION SWALE

CHAINAGE 0.000 TO 37.633 HORIZONTAL 1:250 VERTICAL 1:100 @ A1

— EDGE OF CUL-DE-SAC 16.696 25.000 4.735% 3.000% 3.511% 4.042% 1.989% **DEPTHS** DESIGN SURFACE **EXISTING** SURFACE CHAINAGE

WARNING
BEWARE OF UNDERGROUND
SERVICES
THE LOCATION OF UNDERGROUND SERVICES ARE
APPROXIMATE ONLY AND THEIR EXACT POSITION
SHOULD BE PROVEN ON SITE. NO GUARANTEE IS
GIVEN THAT ALL EXISTING SERVICES ARE SHOWN.

LONGITUDINAL SECTION - ROAD 01 MC01

CHAINAGE 0.000 TO 174.927 HORIZONTAL 1:250 VERTICAL 1:100 @ A1



DATE OF SURVEY: 28 MAR 2025

DATUM: MGA2020, AHD

SCALE: AS NOTED

SIZE: A1






SURVEY	LP	REV	DESCRIPTION
DESIGN	AD	0	SUBMISSION FOR DA APPROVAL
DRAWN	JN		
CHECKED	TP		
APPROVED	JW		

CIVPLAN PTY LIMITED ALL RIGHTS RESERVED.

DATE

25 AUG 25

THIS DOCUMENT IS PRODUCED BY CIVPLAN PTY LTD SOLELY FOR THE BENEFIT OF AND USE BY THE CLIENT IN ACCORDANCE WITH THE TERMS OF THE RETAINER. CIVPLAN PTY LTD DOES NOT AND SHALL NOT ASSUME ANY RESPONSIBILITY OR LIABILITY WHATSOEVER TO ANY THIRD PARTY ARISING OUT OF ANY USE OF RELIANCE BY THIRD PARTY ON THE CONTENT OF THIS DOCUMENT.

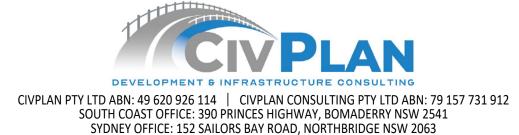


T: 1800 318 052 E: info@civplan.com.au W: www.civplan.com.au

OB NAME: 8 LOT RESIDENTIAL SUBDIVISION	FOR CONCEPT APPROVAL		
OCATION: 27 BONNETT DRIVE, RUN-O-WATERS, NSW LOT 24 DP 1053904	NOT TO BE USED FOR CONSTRUCTION PURPOSES		
LGA: GOULBURN MULWAREE COUNCIL	RELEASE DATE: 25 AUGUST 2025		
CLIENT: KIMBLA PASTORAL COMPANY PTY LTD	JOB-DRAWING NUMBER	REV	
DESCRIPTION: CIVIL ENGINEERING CONCEPT DESIGN	25022 DD 4220	•	
DRAWING: ROAD 0X MC0X LONGITUDINAL AND TYPICAL SECTIONS	25022-RD-1230	0	


0 0.5 1 1.5 2 2.5

SCALE:- 1:100

SCALE:- 1:250

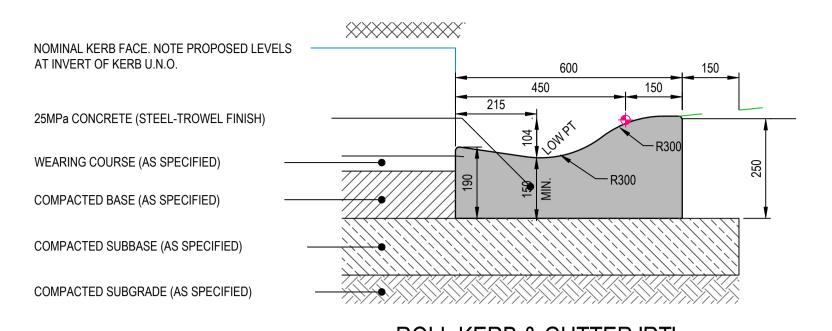


ROLL KERB & GUTTER 'RT' EXPANSION JOINTS @ MAX 12m CTRS / TOOL JOINTS @ MAX 3m CTRS ALL RADII TO BE 20mm U.N.O. SCALE 1:10 @ A1

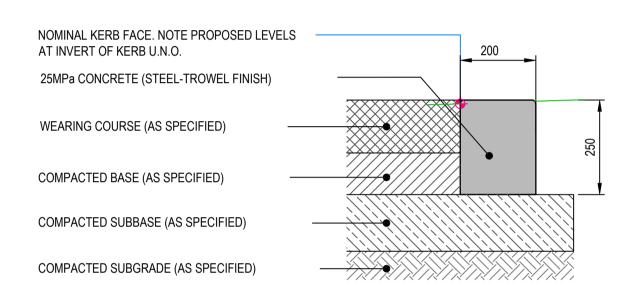

EDGE RESTRAINT - 200mm WIDE 'KS'

EXPANSION JOINTS @ MAX 12m CTRS / TOOL JOINTS @ MAX 3m CTRS ALL RADII TO BE 5mm U.N.O) SCALE 1:10 @ A1

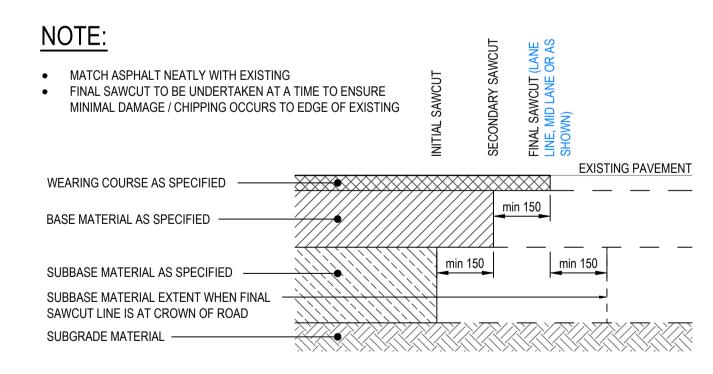

PAVEMENT INTERFACE 'INT1' SCALE 1:10 @ A1





DATE OF SURVEY: 28 MAR 2025

DATUM: MGA2020, AHD

SCALE: AS NOTED

SIZE: A1





	GDA 2020
ion.	

SURVEY	LP	REV	DESCRIPTION	DATE	CIVPLAN PTY LIMITED ALL RIGHTS RESERVED.	
DESIGN	AD	0	SUBMISSION FOR DA APPROVAL	25 AUG 25		
DRAWN	JN				AND USE BY THE CLIENT IN ACCORDANCE WITH THE TERMS OF THE RETAINER. CIVPLAN PTY LTD DOES NOT AND SHALL NOT ASSUME ANY RESPONSIBILITY OR	DEVELOPMENT & INFRASTRUCTURE CONSU
CHECKED	TP				LIABILITY WHATSOEVER TO ANY THIRD PARTY ARISING OUT OF ANY USE OF	CIVPLAN PTY LTD ABN: 49 620 926 114 CIVPLAN CONSULTING PTY SOUTH COAST OFFICE: 390 PRINCES HIGHWAY, BOMADER
APPROVED	JW				RELIANCE BY THIRD PARTY ON THE CONTENT OF THIS DOCUMENT.	SYDNEY OFFICE: 152 SAILORS BAY ROAD, NORTHBRIDGI T: 1800 318 052 E: info@civplan.com.au W: www.civp




IOB NAME: 8 LOT RESIDENTIAL SUBDIVISION LOCATION: 27 BONNETT DRIVE, RUN-O-WATERS, NSW LOT 24 DP 1053904	FOR CONCEPT APPROVAL NOT TO BE USED FOR CONSTRUCTION PURPOSES		
LGA: GOULBURN MULWAREE COUNCIL	RELEASE DATE: 25 AUGUST 2025		
CLIENT: KIMBLA PASTORAL COMPANY PTY LTD	JOB-DRAWING NUMBER	REV	
DESCRIPTION: CIVIL ENGINEERING CONCEPT DESIGN	25022 DD 4200	0	
DRAWING: ROAD AND PAVEMENT TYPICAL DETAILS	25022-RD-1280	U	

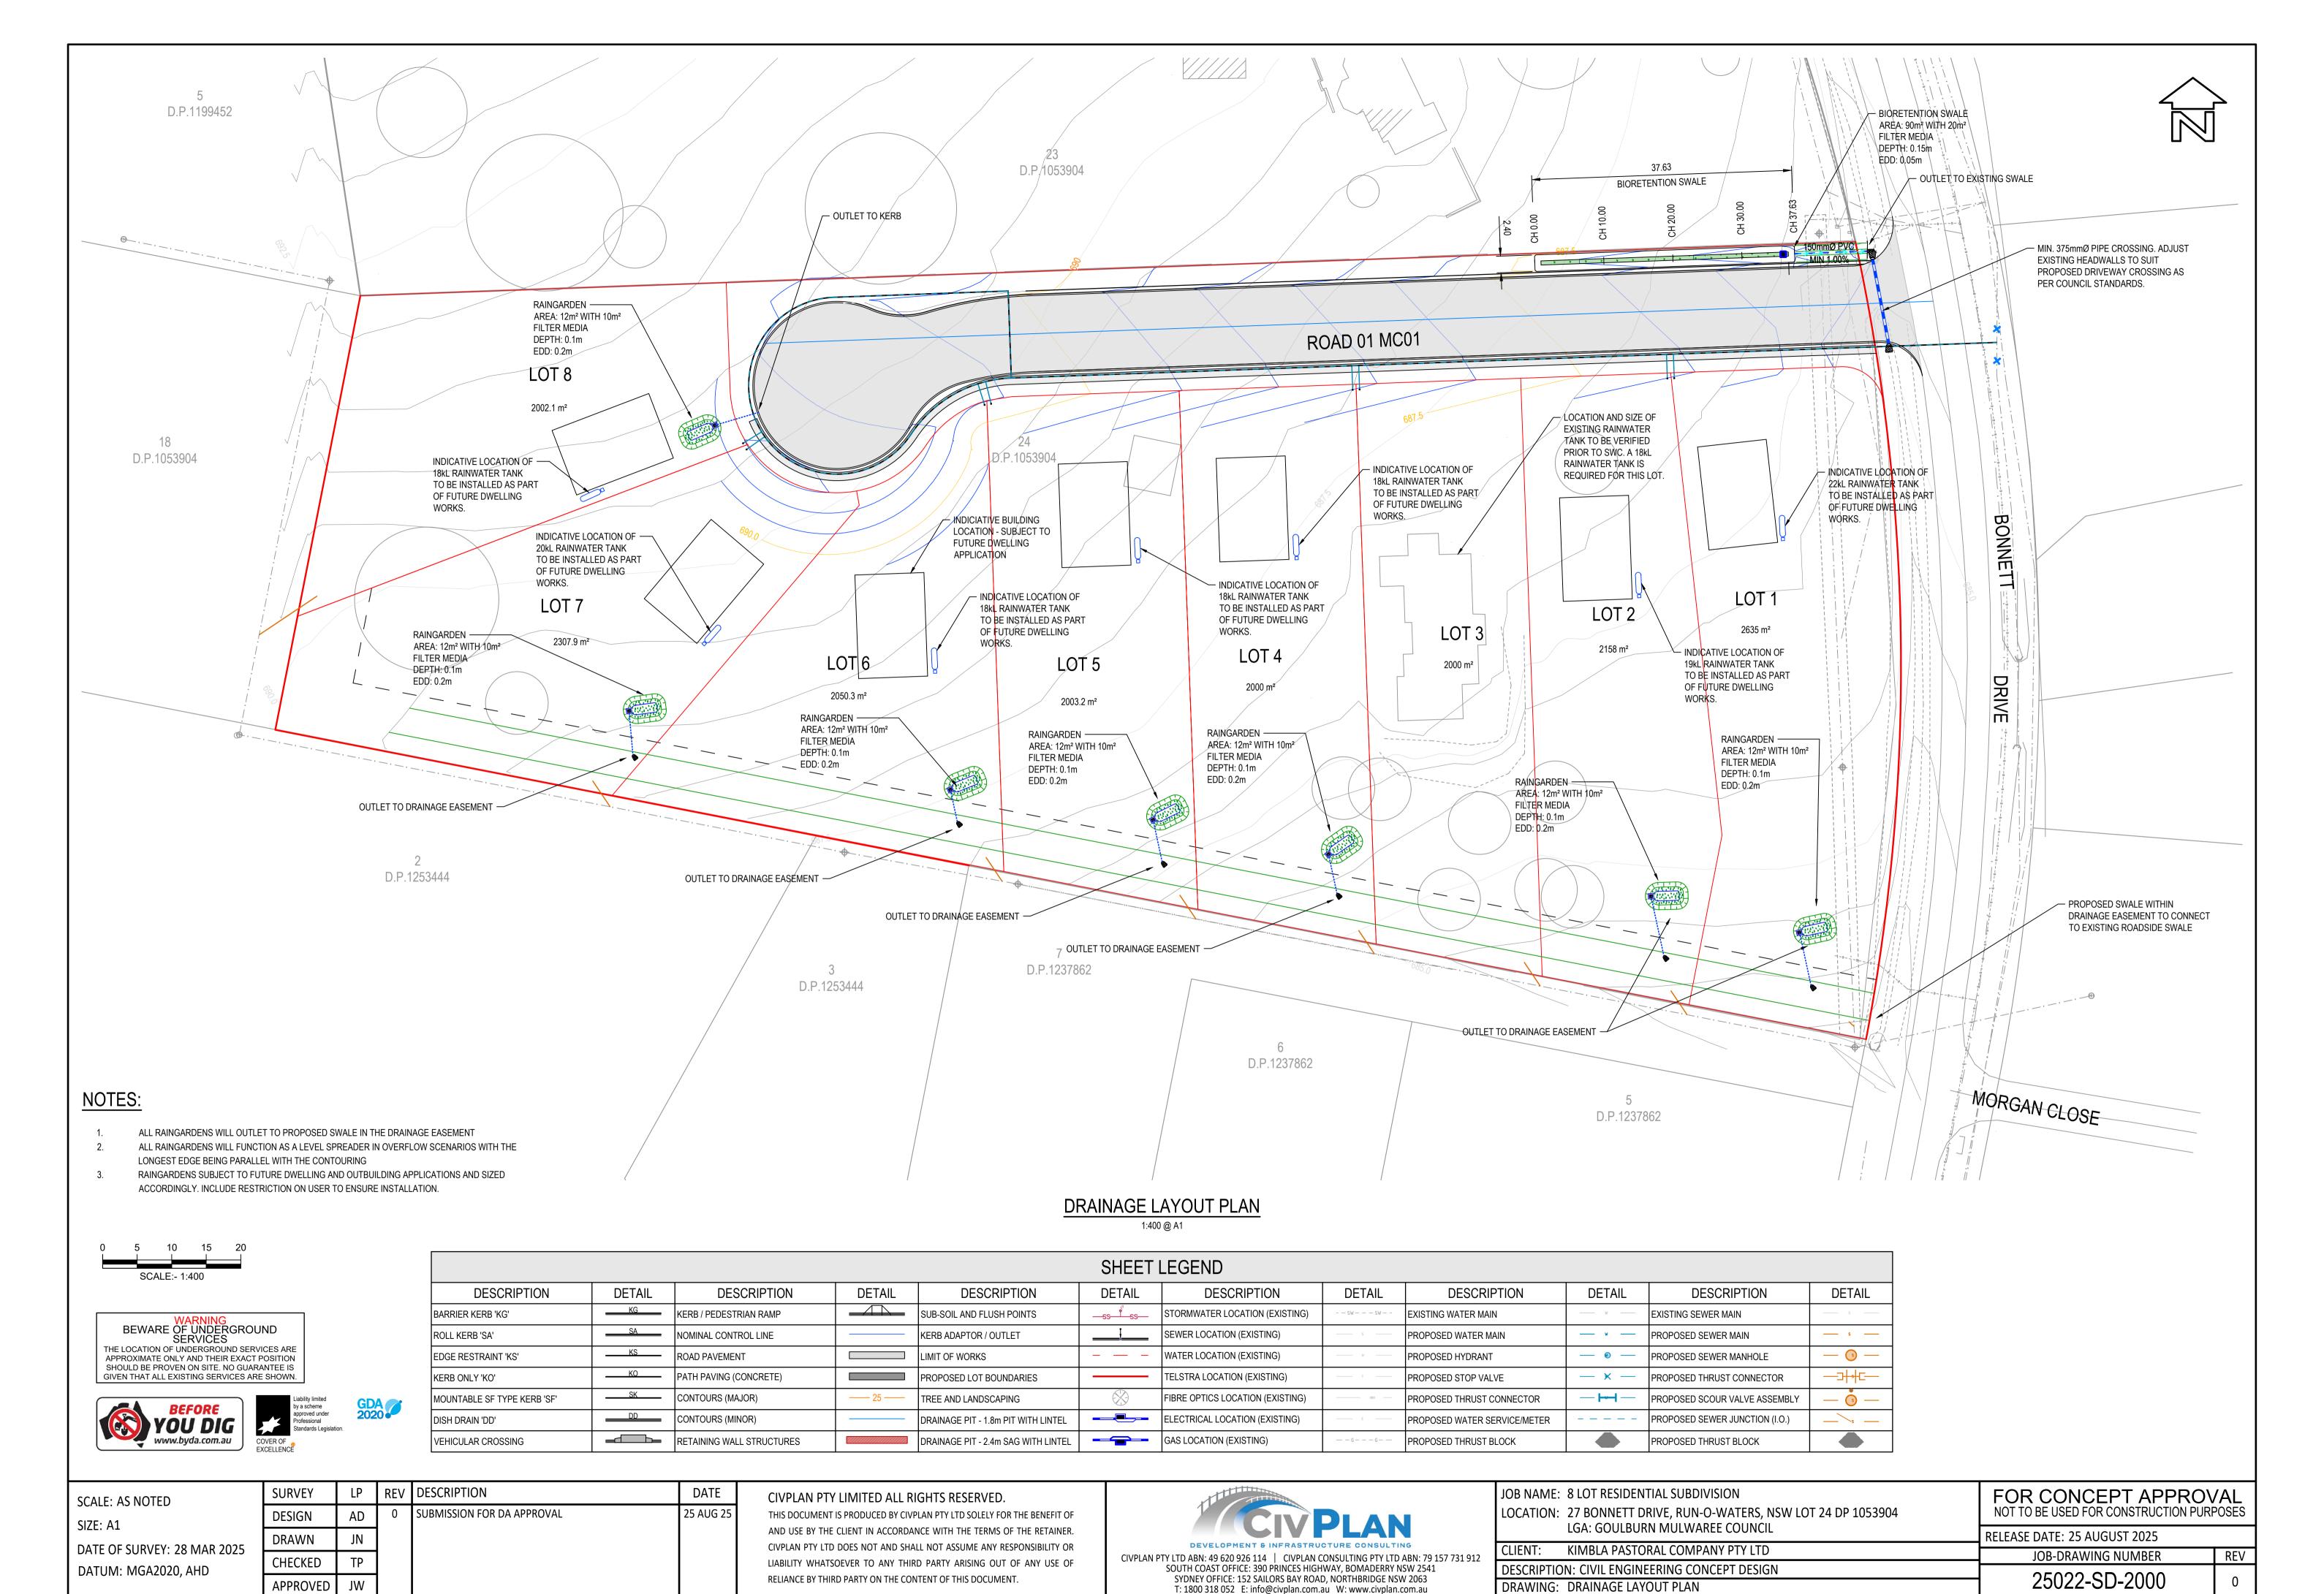

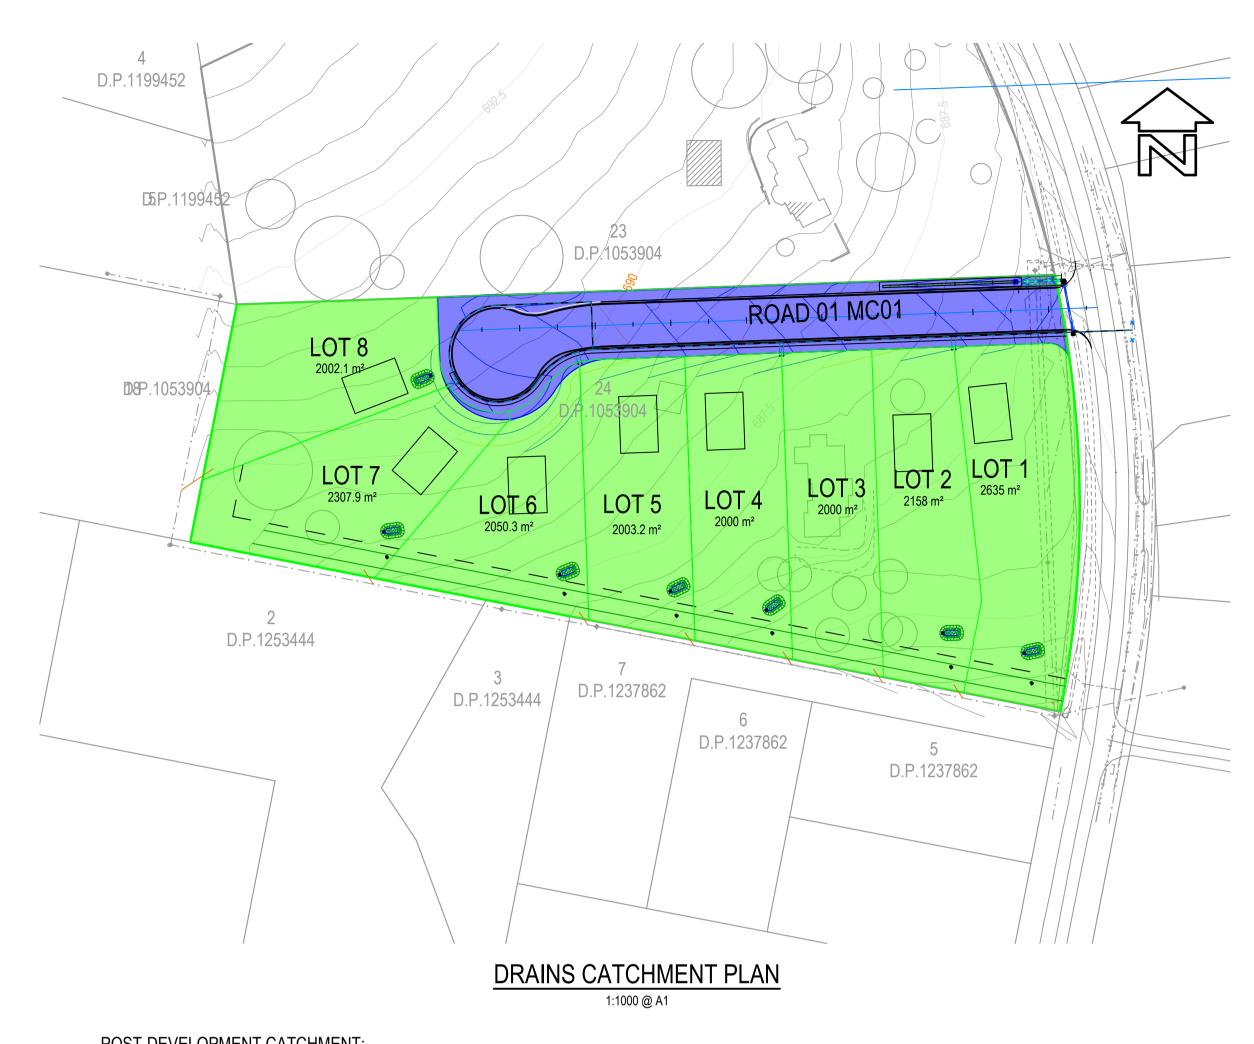

POST-DEVELOPMENT CATCHMENT:

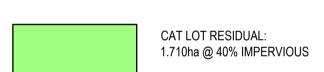



ROAD RESERVE: 0.337ha @ 90% IMPERVIOUS


LOT PERMISSIBLE SITE DISCHARGE (PSD) REQUIREMENT								
CRITICAL STORM	PRE DEV SITE	POST DEV SITE	POST DEV ROADS	POST DEV SITE - PRE DEV SITE	PSD REQU	JIREMENT		
% AEP	m3/s	m3/s	m3/s	m3/s	m3/s/ha	L/s/ha		
50	0.056	0.154	0.053	0.003	0.001	1.47		
20	0.104	0.276	0.073	0.031	0.015	15.14		
10	0.133	0.349	0.086	0.047	0.023	22.96		
5	0.170	0.402	0.098	0.072	0.035	35.17		
2	0.226	0.492	0.114	0.112	0.055	54.71		
1	0.278	0.554	0.125	0.153	0.075	74.74		

27 BONNET DRIVE - DRAINS CATCHMENT						
PRE DEVELOPMENT						
SITE	2.047	ha	6% IMP			

27 BONNET DRIVE - DRAINS CATCHMENT							
POST DEVELOPMENT							
SITE LOTS	1.710	ha	40% IMP				
SITE DRIVEWAY	0.337	ha	90% IMP				

CRITICAL STORM	PRE DEV VOL	POST DEV VOL	SSR FOR LO	TS
% AEP	m3	m3	m3	m3/ha
1% _{2hour}	829.0	960.8	131.8	64

LOT	AREA	OSD REQUIRED	
	ha	m3	L
LOT 1	0.264	17	17000
LOT 2	0.216	14	14000
LOT 3	0.200	13	13000
LOT 4	0.200	13	13000
LOT 5	0.200	13	13000
LOT 6	0.205	13	13000
LOT 7	0.231	15	15000
LOT 8	0.200	13	13000

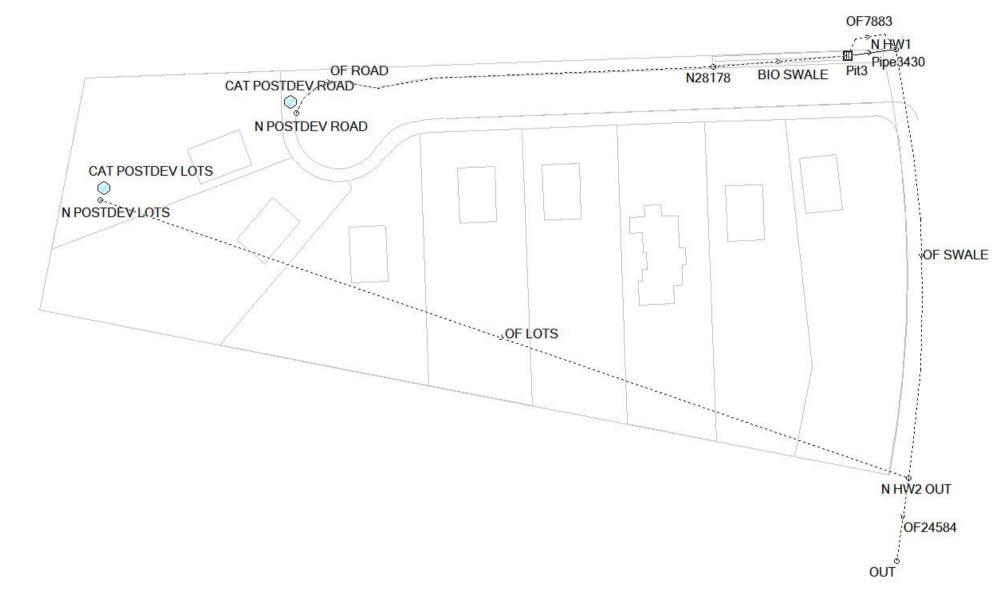


POST DEVELOPMENT DRAINS MODEL

Cat PRE DEV N PRE DEV OF PRE DEV N PRE DEV OUT

PRE DEVELOPMENT DRAINS MODEL

DRAINS MODELLING NOTES:

- RAINFALL DATA FROM GOULBURN, NSW ARR2019 PROTOCOLS FROM THE NEAREST
- GRID CELL LONGITUDE 149.6875 (E) AND LATITUDE 34.7625 (S)
- COUNCIL REQUIREMENTS TO MATCH PRE & POST DEVELOPMENT FLOWS FOR 50%, 20%, 10%, 5%, 2% AND 1% AEP STORM EVENTS

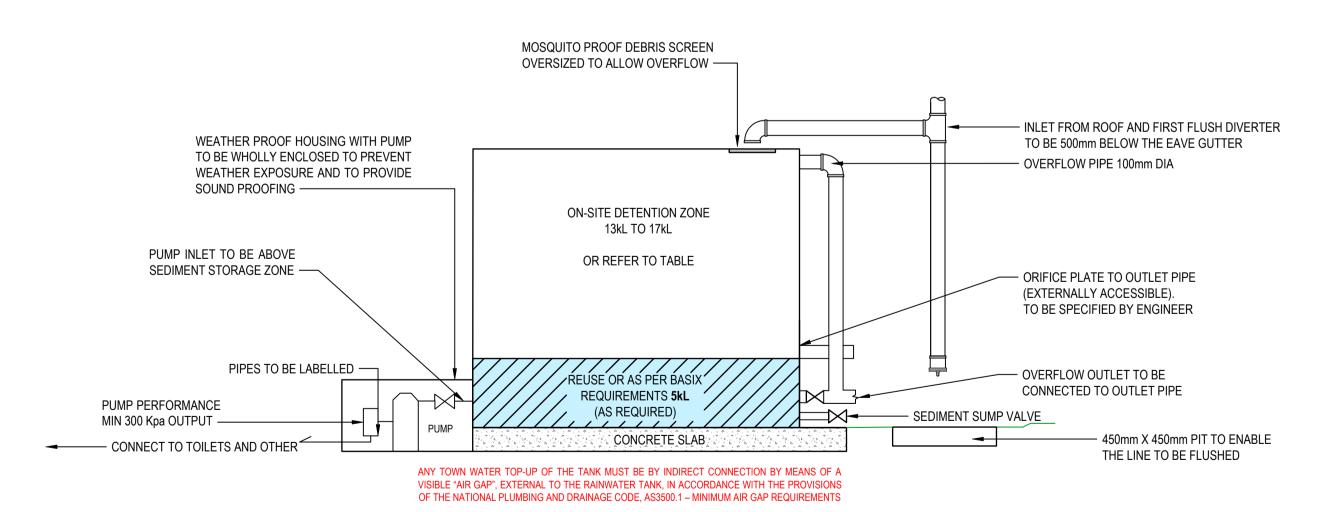

TYPICAL RAINWATER / OSD AT-SOURCE TANK


SCALE: AS NOTED	SURVEY	LP	REV	DESCRIPTION	DATE
SIZE: A1	DESIGN	AD	0	SUBMISSION FOR DA APPROVAL	25 AUG 25
DATE OF SURVEY: 28 MAR 2025 DATUM: MGA2020, AHD	DRAWN	JN			
	CHECKED	TP			
	APPROVED	JW			


CIVPLAN PTY LIMITED ALL RIGHTS RESERVED. THIS DOCUMENT IS PRODUCED BY CIVPLAN PTY LTD SOLELY FOR THE BENEFIT OF AND USE BY THE CLIENT IN ACCORDANCE WITH THE TERMS OF THE RETAINER. CIVPLAN PTY LTD DOES NOT AND SHALL NOT ASSUME ANY RESPONSIBILITY OR LIABILITY WHATSOEVER TO ANY THIRD PARTY ARISING OUT OF ANY USE OF


RELIANCE BY THIRD PARTY ON THE CONTENT OF THIS DOCUMENT.



IOB NAME: 8 LOT RESIDENTIAL SUBDIVISION LOCATION: 27 BONNETT DRIVE, RUN-O-WATERS, NSW LOT 24 DP 1053904	FOR CONCEPT APPROVAL NOT TO BE USED FOR CONSTRUCTION PURPOSES		
LGA: GOULBURN MULWAREE COUNCIL	RELEASE DATE: 25 AUGUST 2025		
CLIENT: KIMBLA PASTORAL COMPANY PTY LTD	JOB-DRAWING NUMBER	REV	
DESCRIPTION: CIVIL ENGINEERING CONCEPT DESIGN	25022 CO 2055	_	
DRAWING: STORMWATER QUANTITY MODELLING PLAN	25022-SQ-2055		

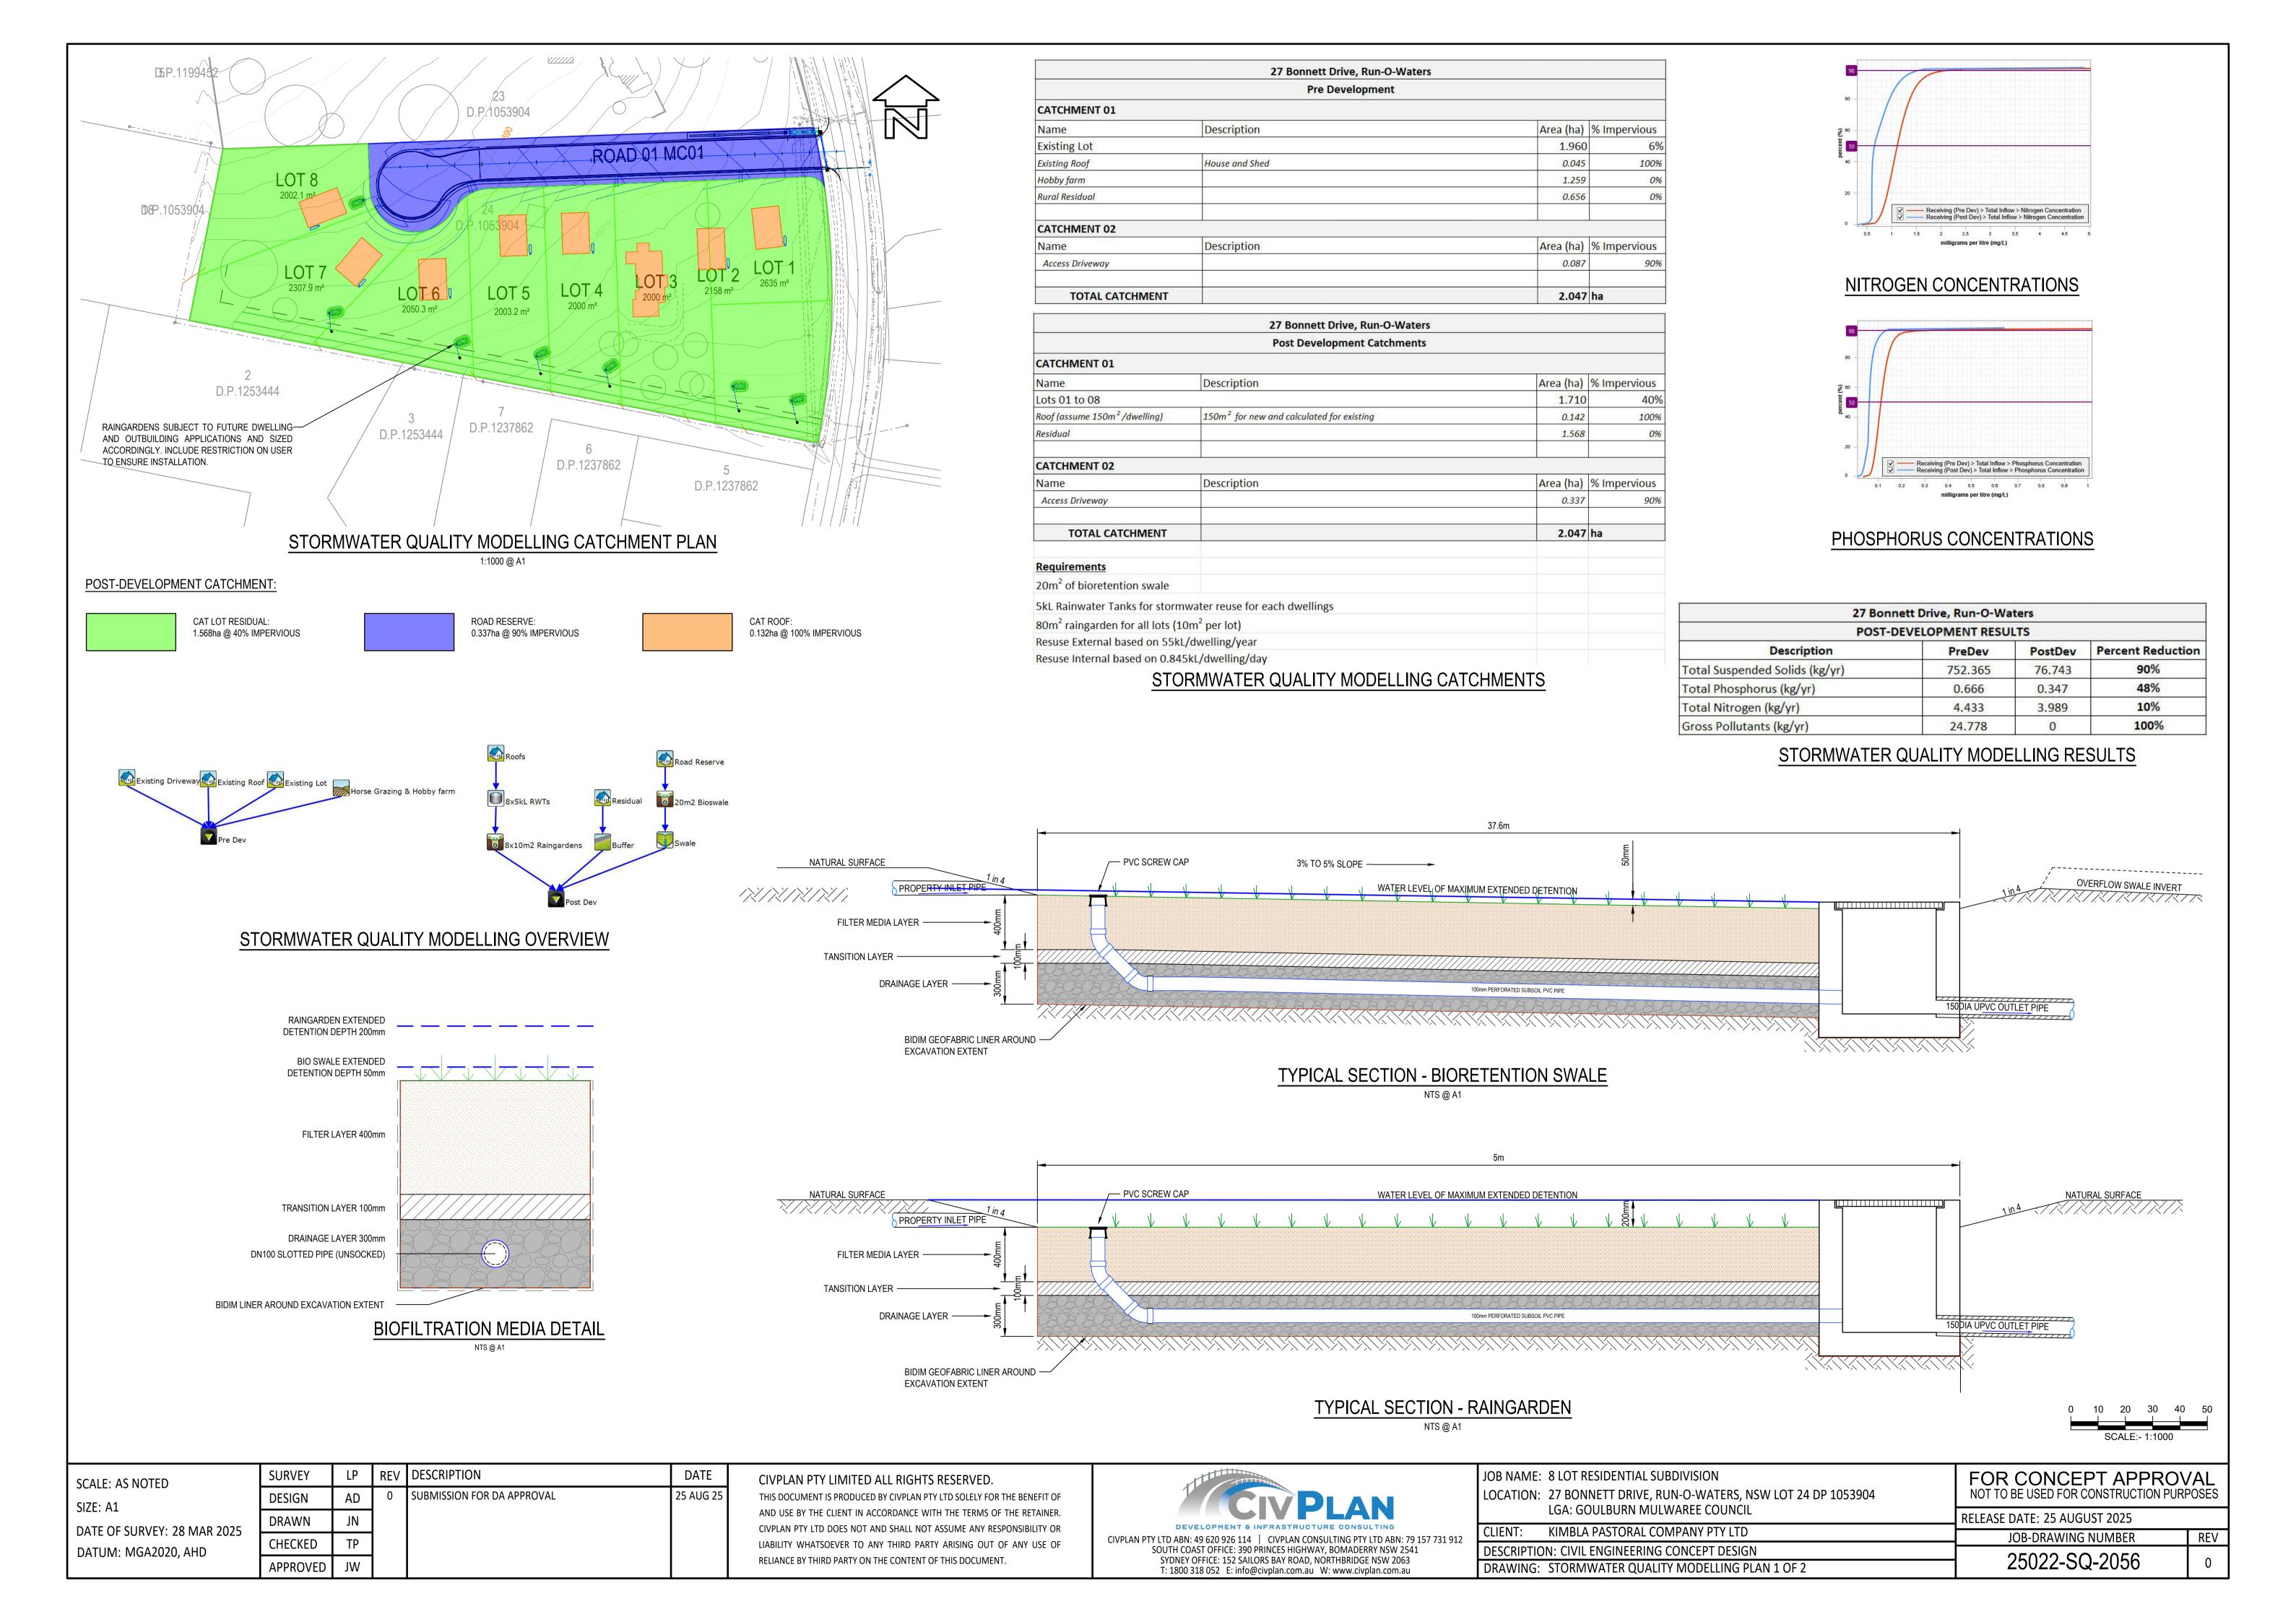

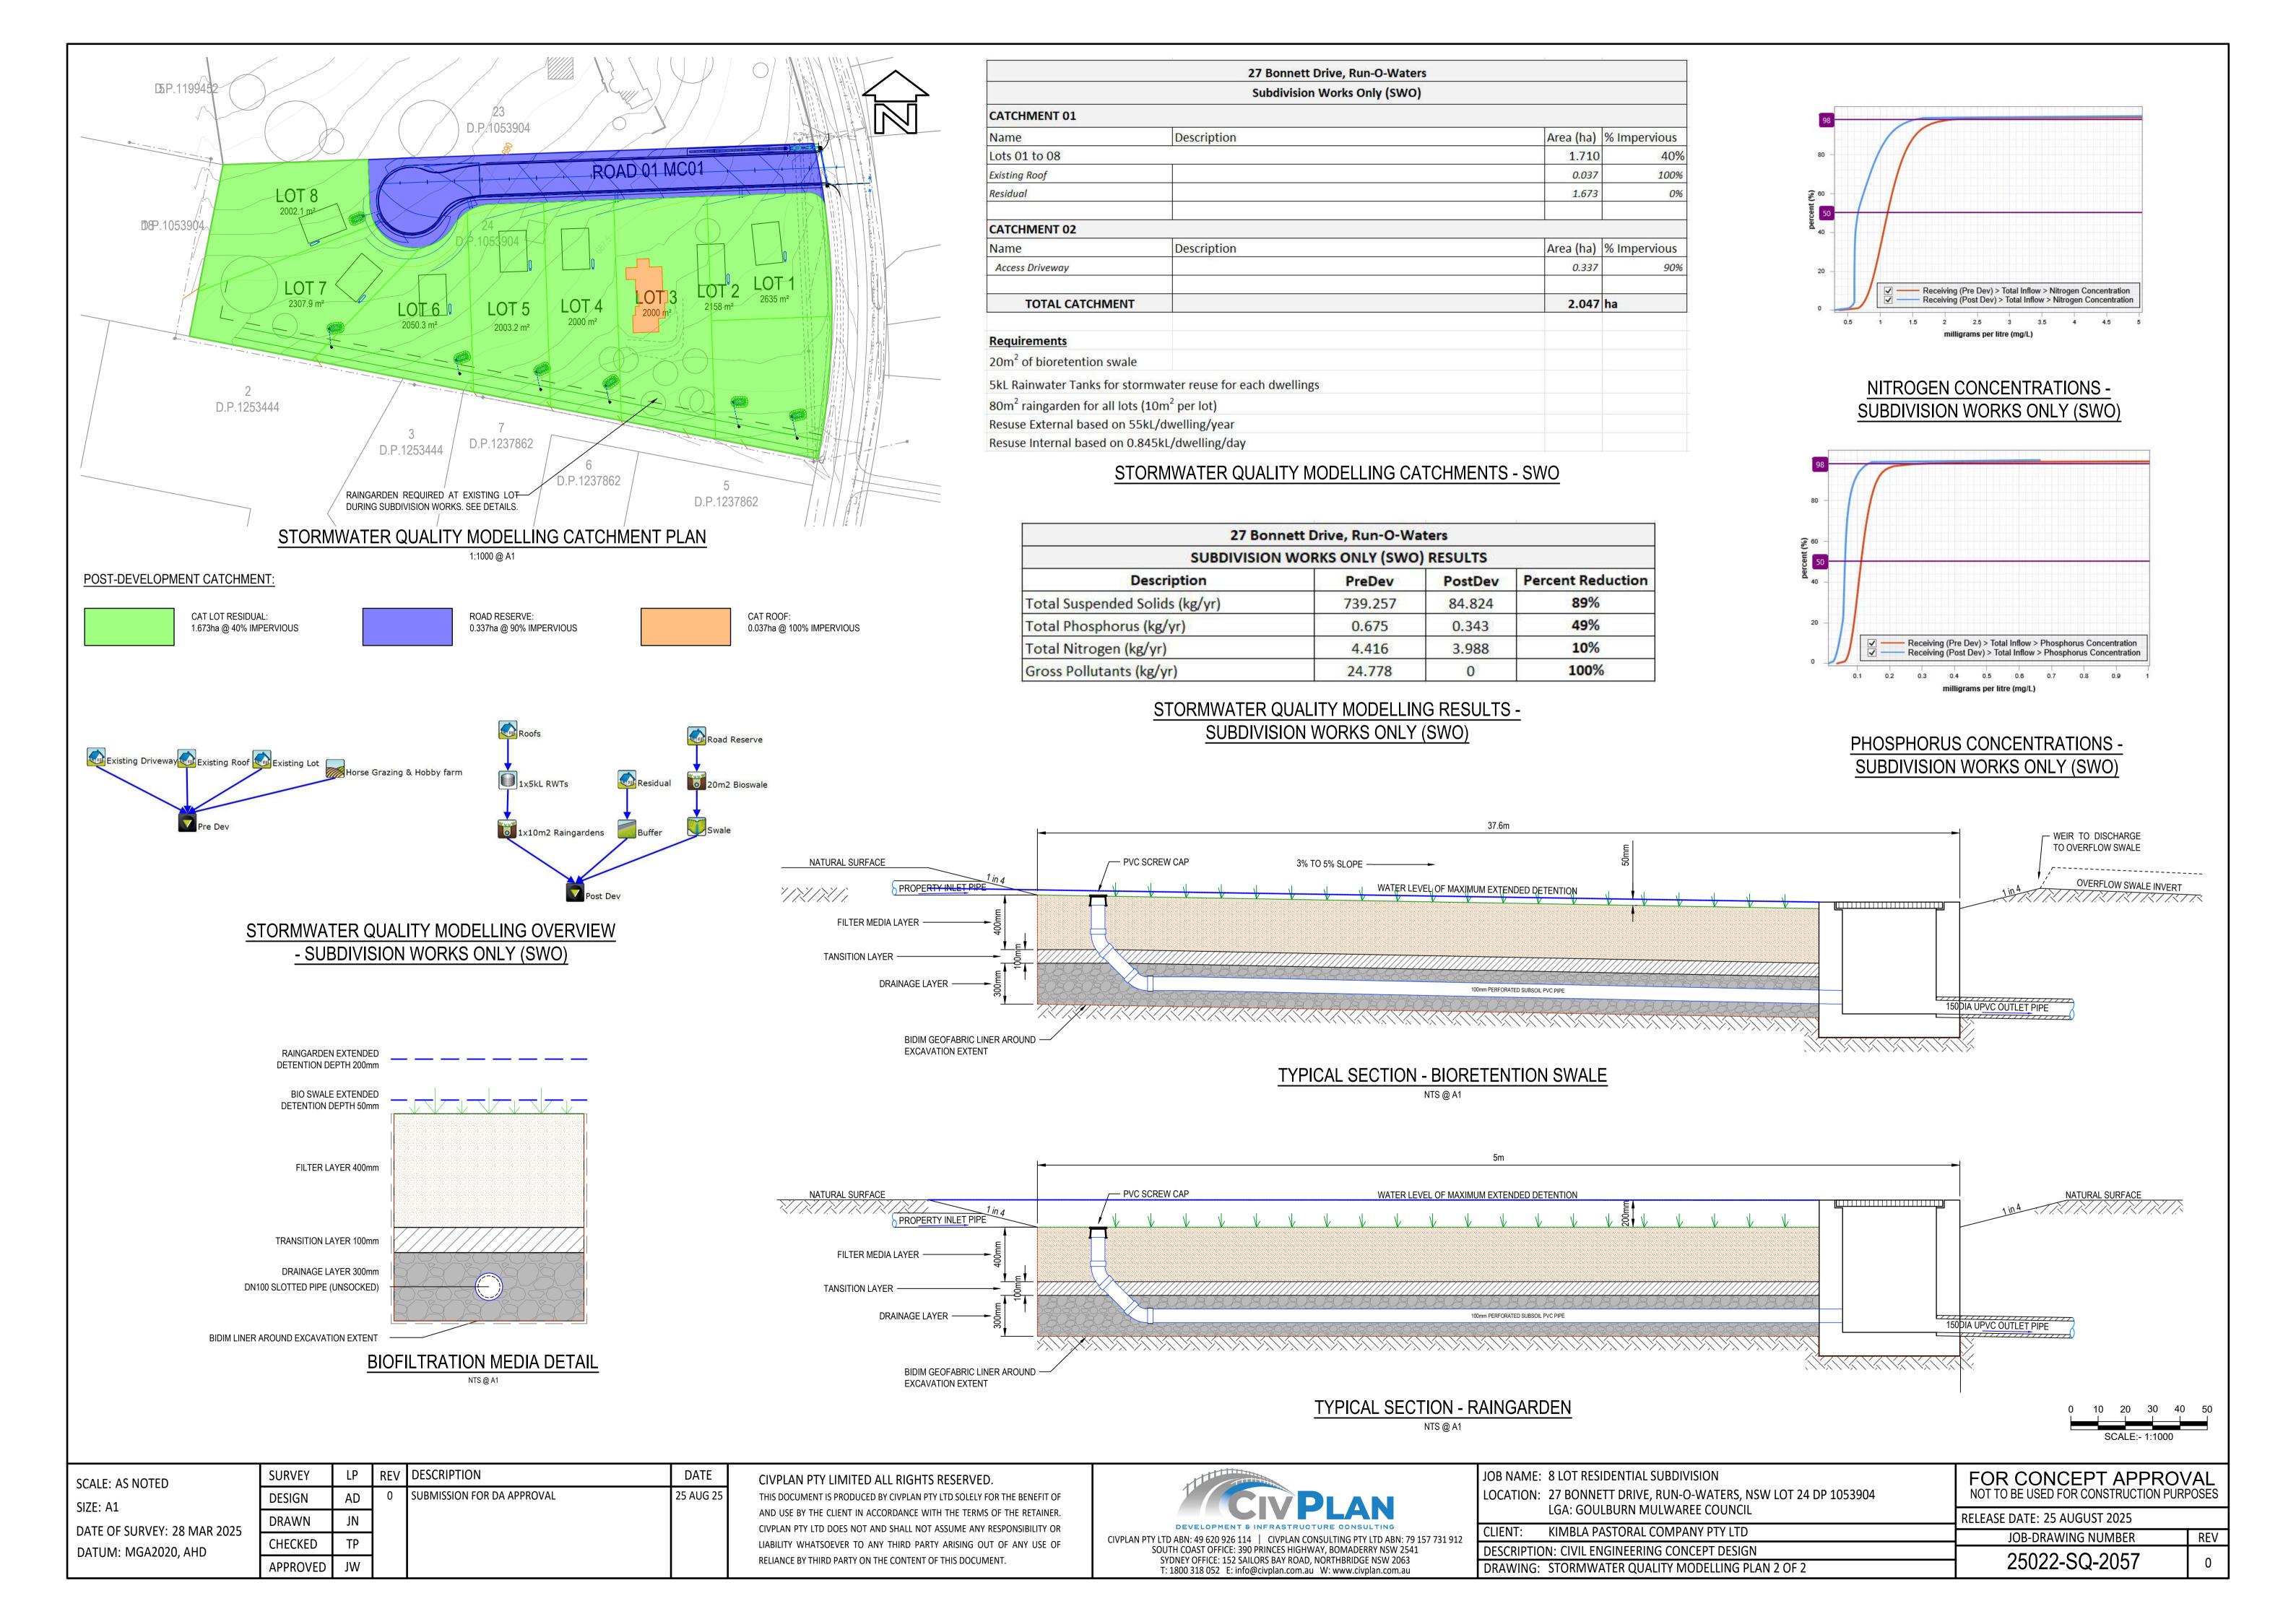

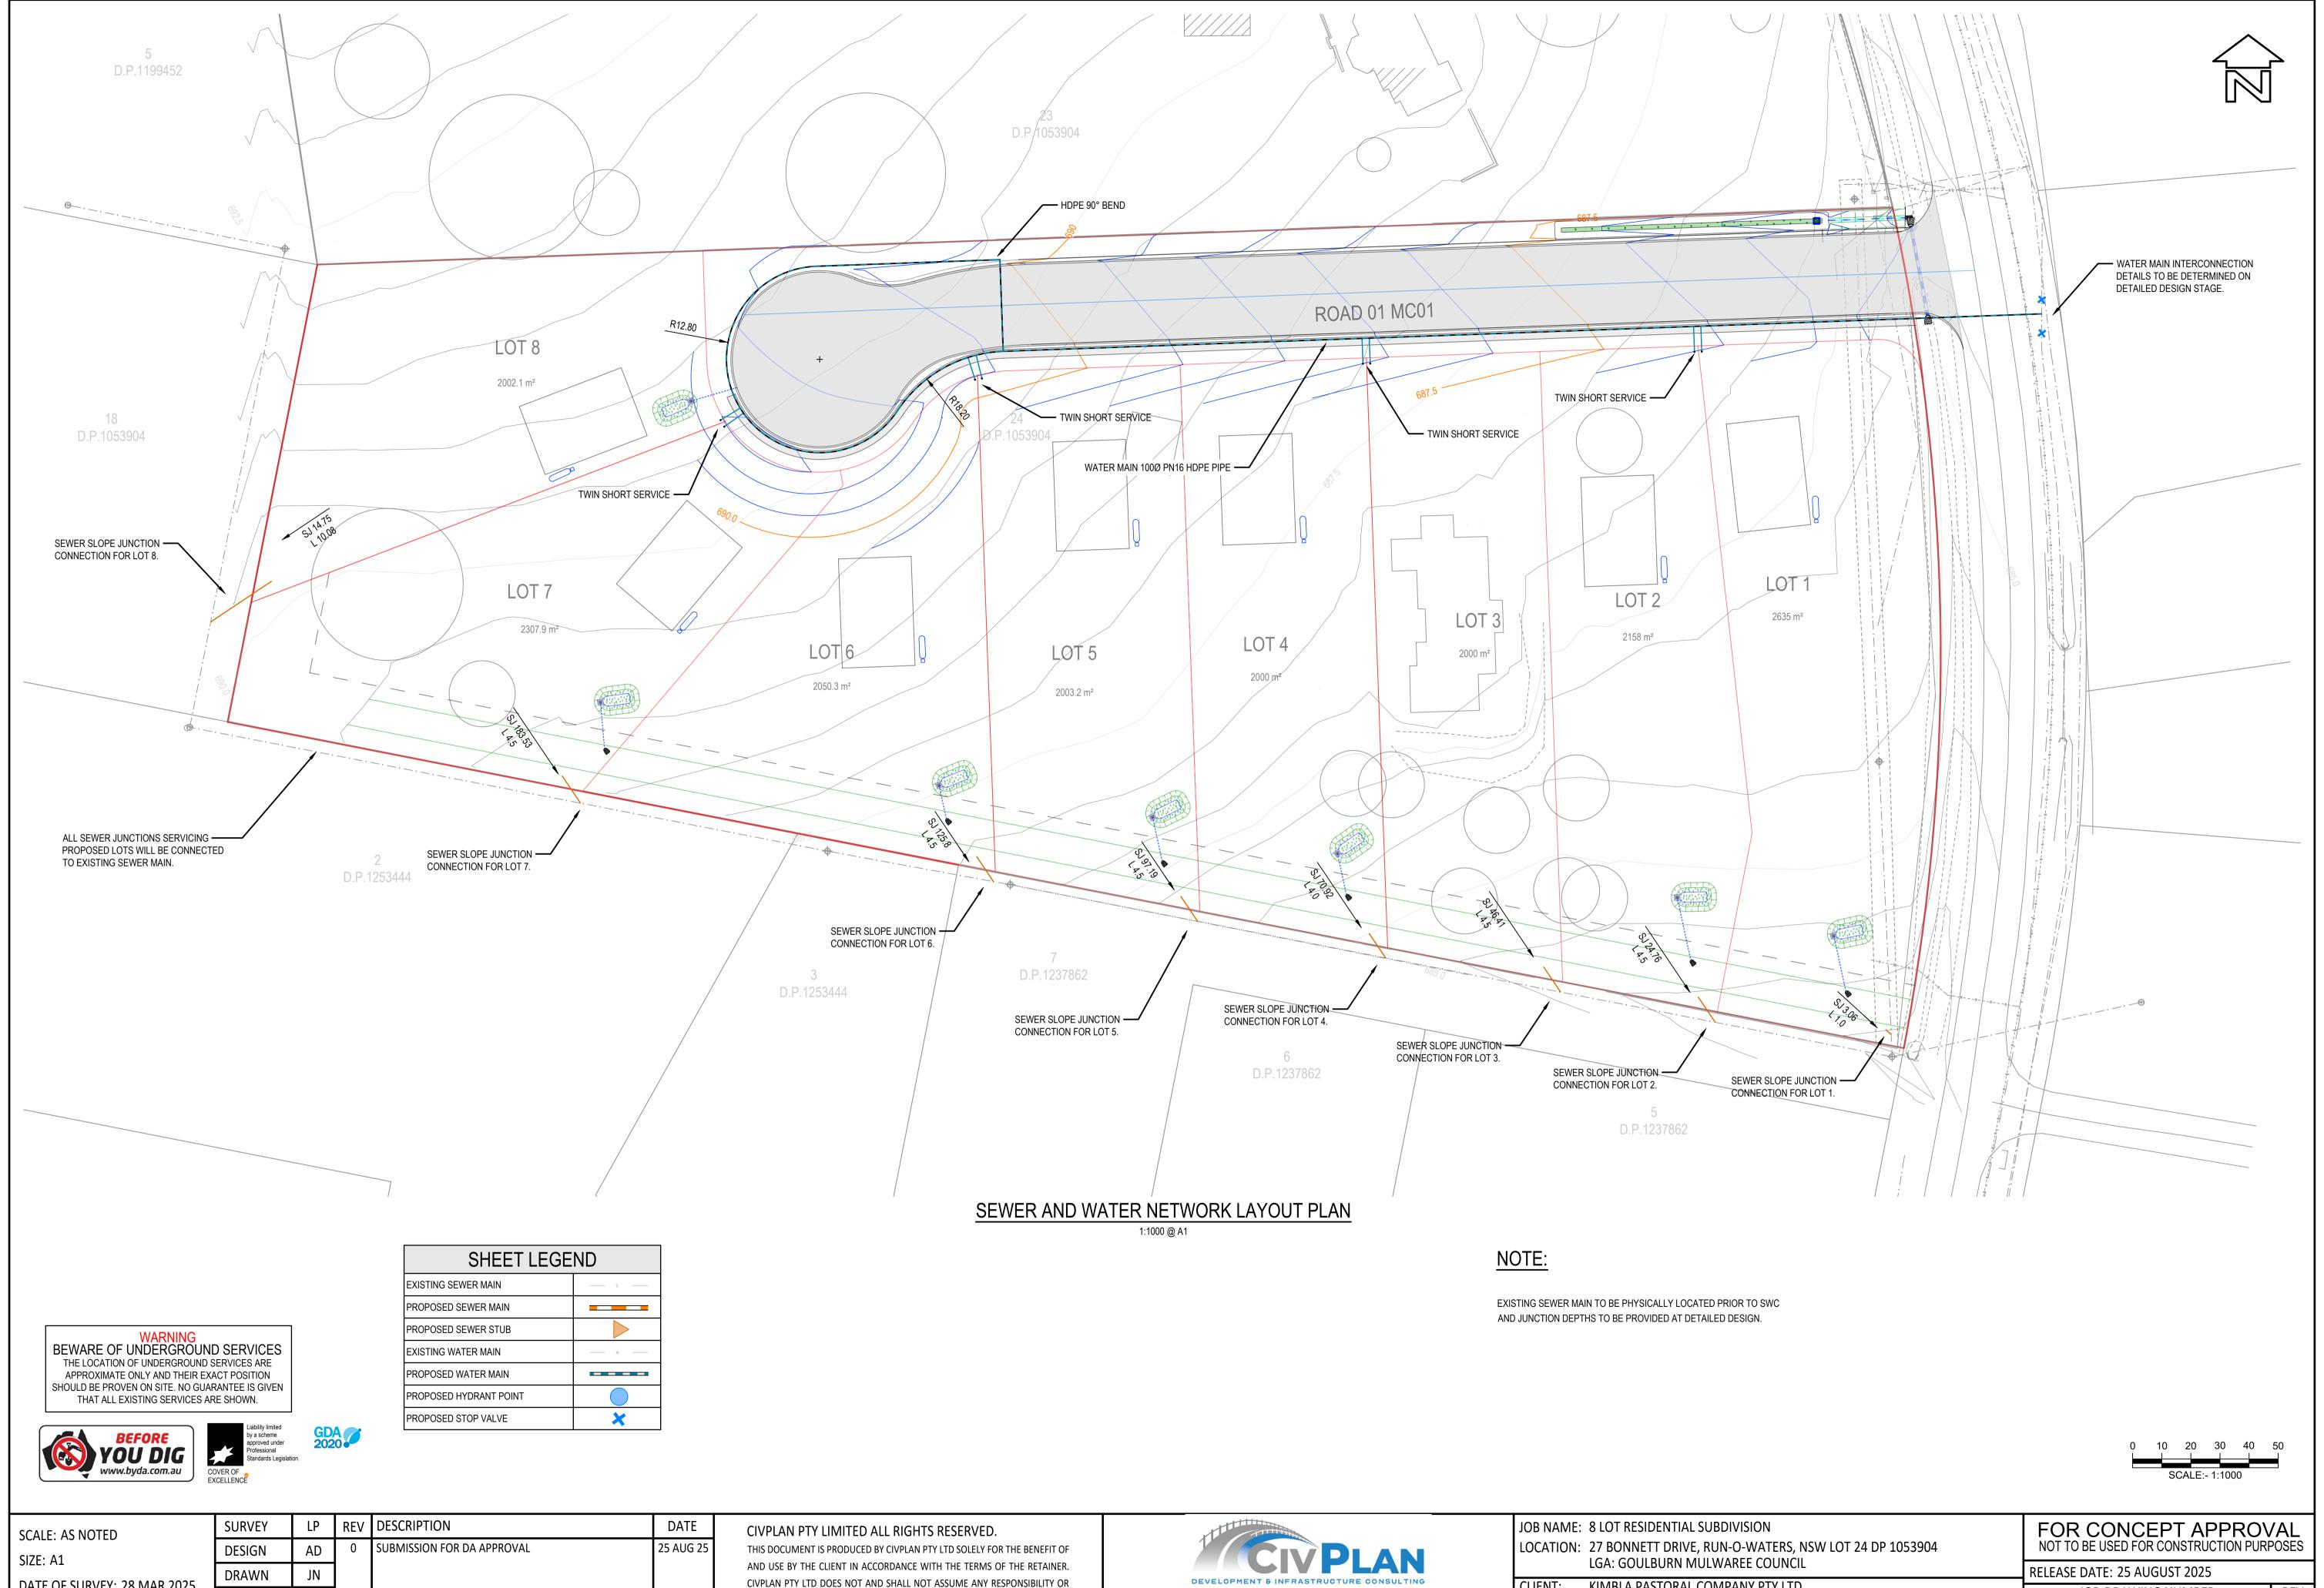

DATE OF SURVEY: 28 MAR 2025 DATUM: MGA2020, AHD

CHECKED APPROVED

CIVPLAN PTY LTD DOES NOT AND SHALL NOT ASSUME ANY RESPONSIBILITY OR LIABILITY WHATSOEVER TO ANY THIRD PARTY ARISING OUT OF ANY USE OF RELIANCE BY THIRD PARTY ON THE CONTENT OF THIS DOCUMENT.

CIVPLAN PTY LTD ABN: 49 620 926 114 | CIVPLAN CONSULTING PTY LTD ABN: 79 157 731 912 SOUTH COAST OFFICE: 390 PRINCES HIGHWAY, BOMADERRY NSW 2541 SYDNEY OFFICE: 152 SAILORS BAY ROAD, NORTHBRIDGE NSW 2063 T: 1800 318 052 E: info@civplan.com.au W: www.civplan.com.au

JOB NAME: 8 LOT RESIDENTIAL SUBDIVISION LOCATION: 27 BONNETT DRIVE, RUN-O-WATERS, NSW LOT 24 DP 1053904	FOR CONCEPT APPROVAL NOT TO BE USED FOR CONSTRUCTION PURPOSES		
LGA: GOULBURN MULWAREE COUNCIL	RELEASE DATE: 25 AUGUST 2025		
CLIENT: KIMBLA PASTORAL COMPANY PTY LTD	JOB-DRAWING NUMBER	REV	
DESCRIPTION: CIVIL ENGINEERING CONCEPT DESIGN	25022 CE 2400		
DRAWING: SEWER AND WATER NETWORK LAYOUT PLAN	25022-SE-3100	0	